




2 PARTIAL SECOND FLOOR ENLARGED PLAN  
SCALE: 1/4" = 1'-0"

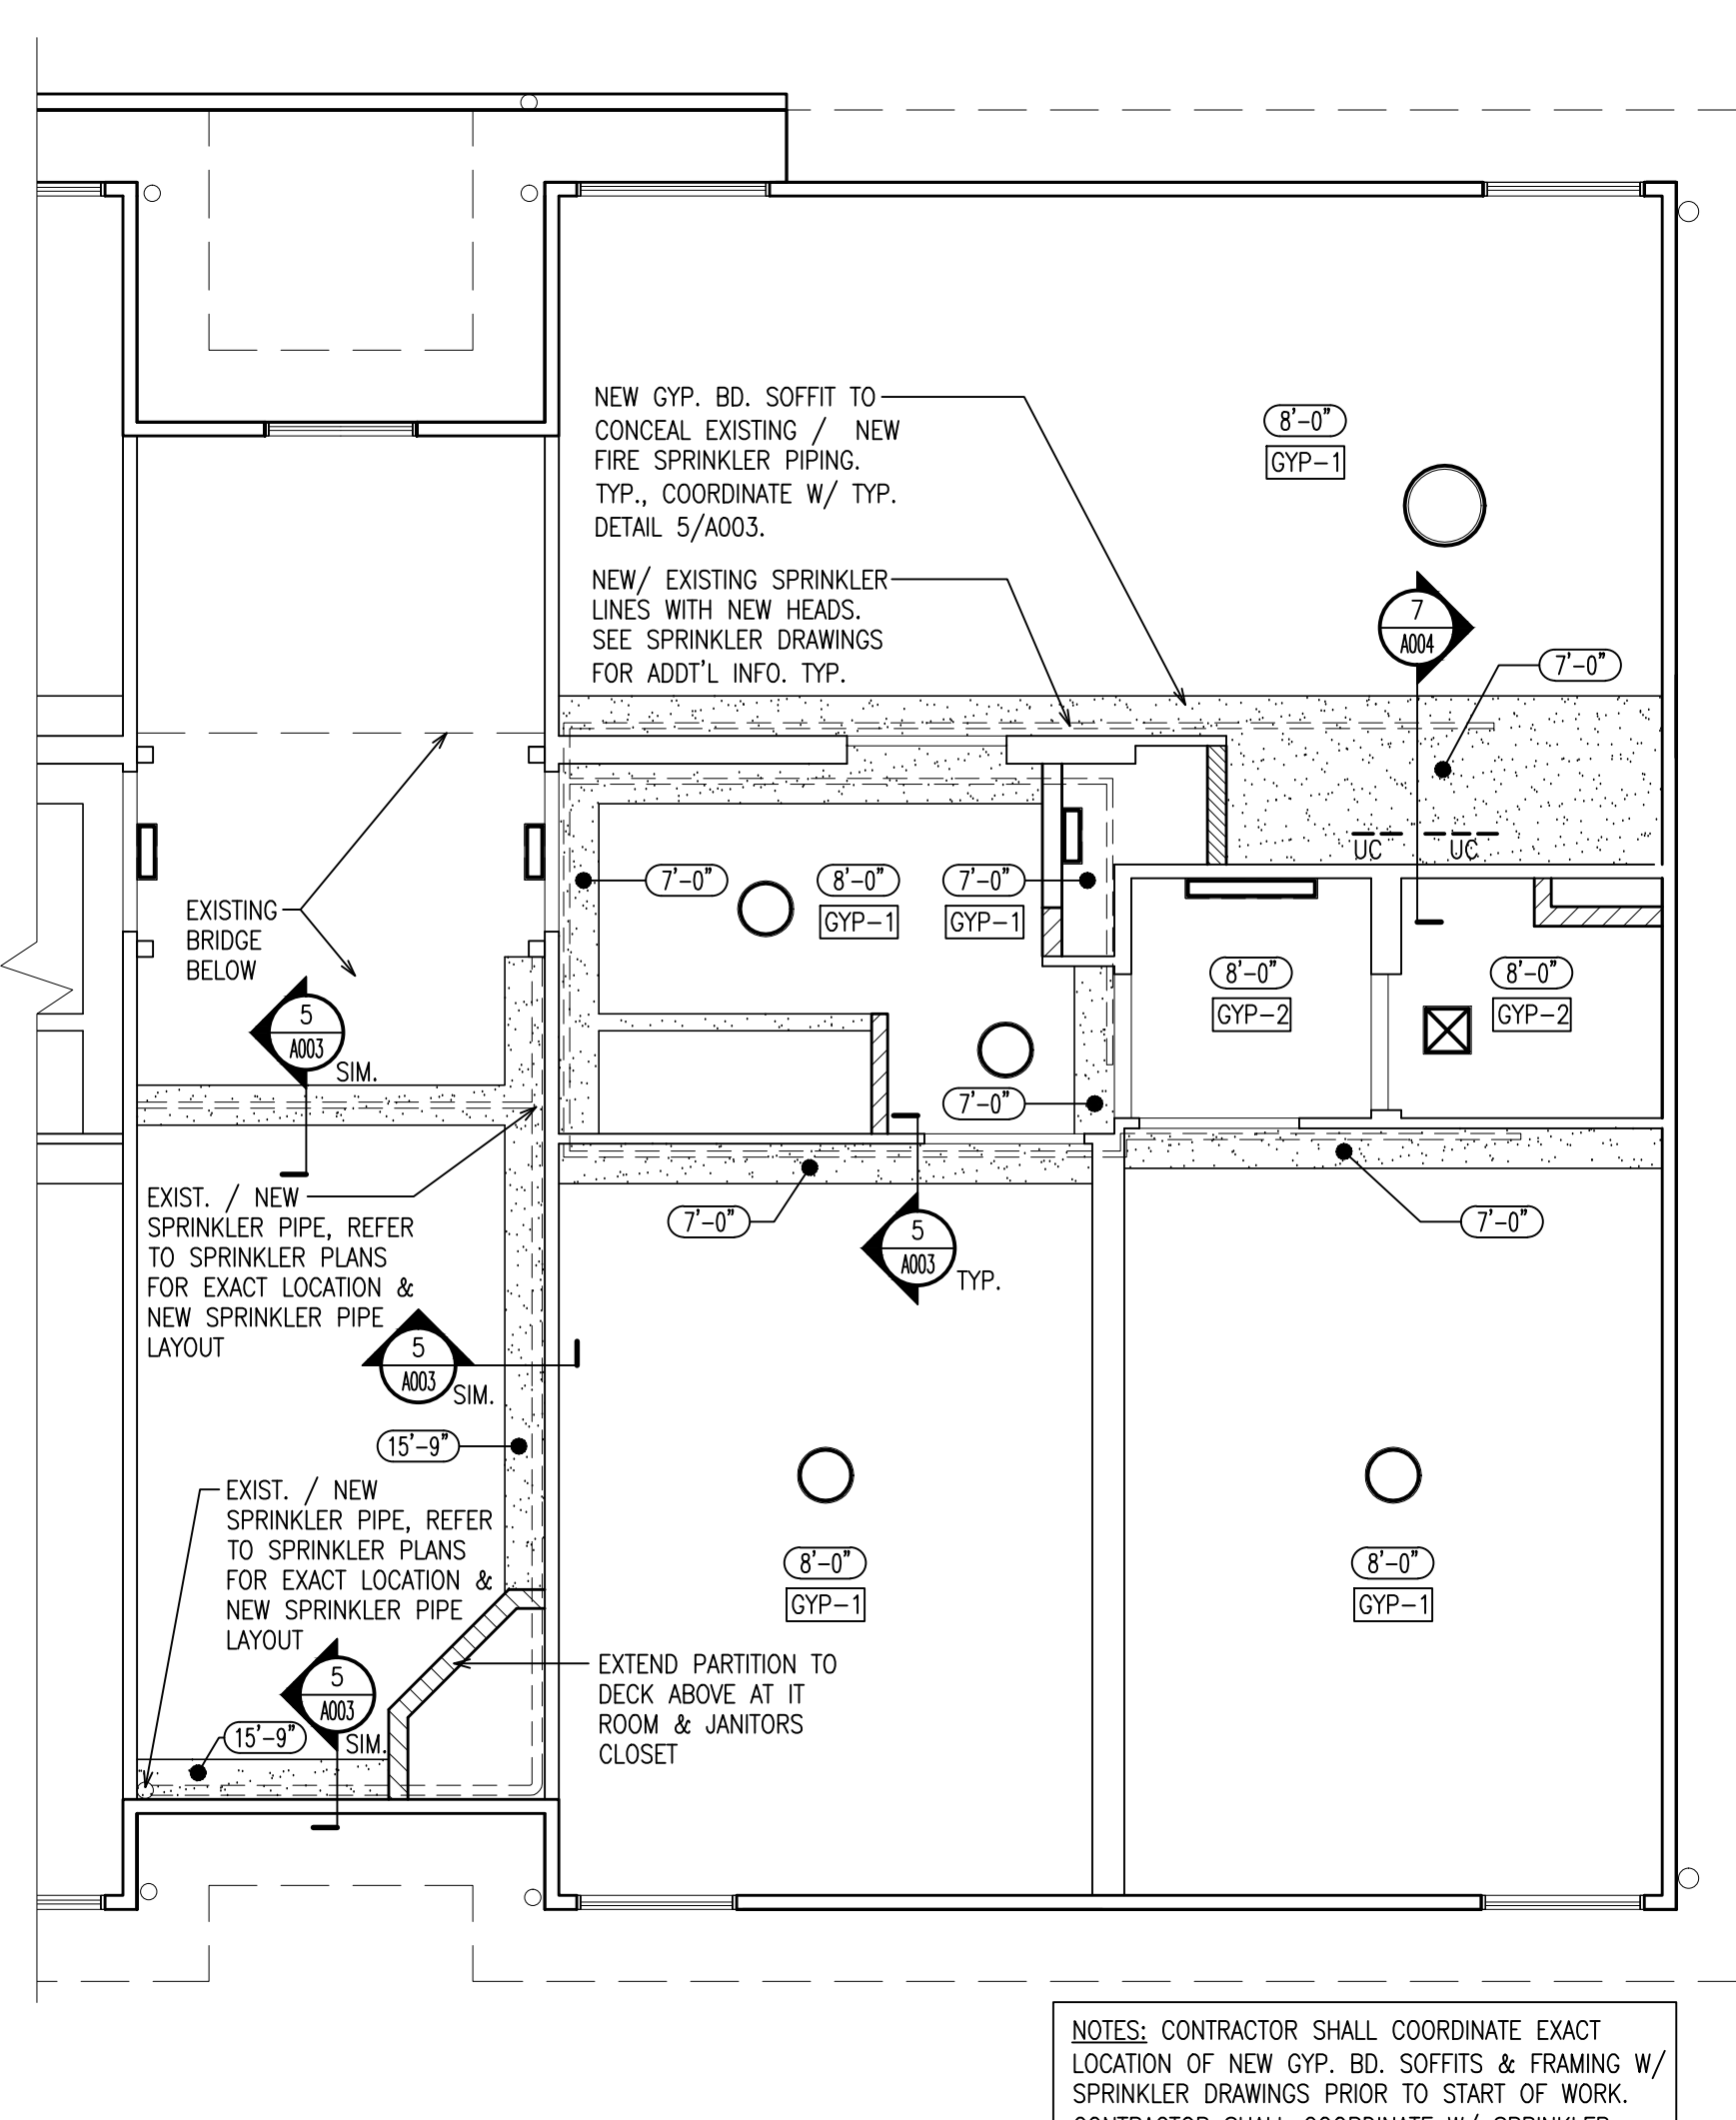


4 PARTIAL SECOND FLOOR  
ENLARGED REFLECTED CEILING PLAN  
SCALE: 1/4" = 1'-0"

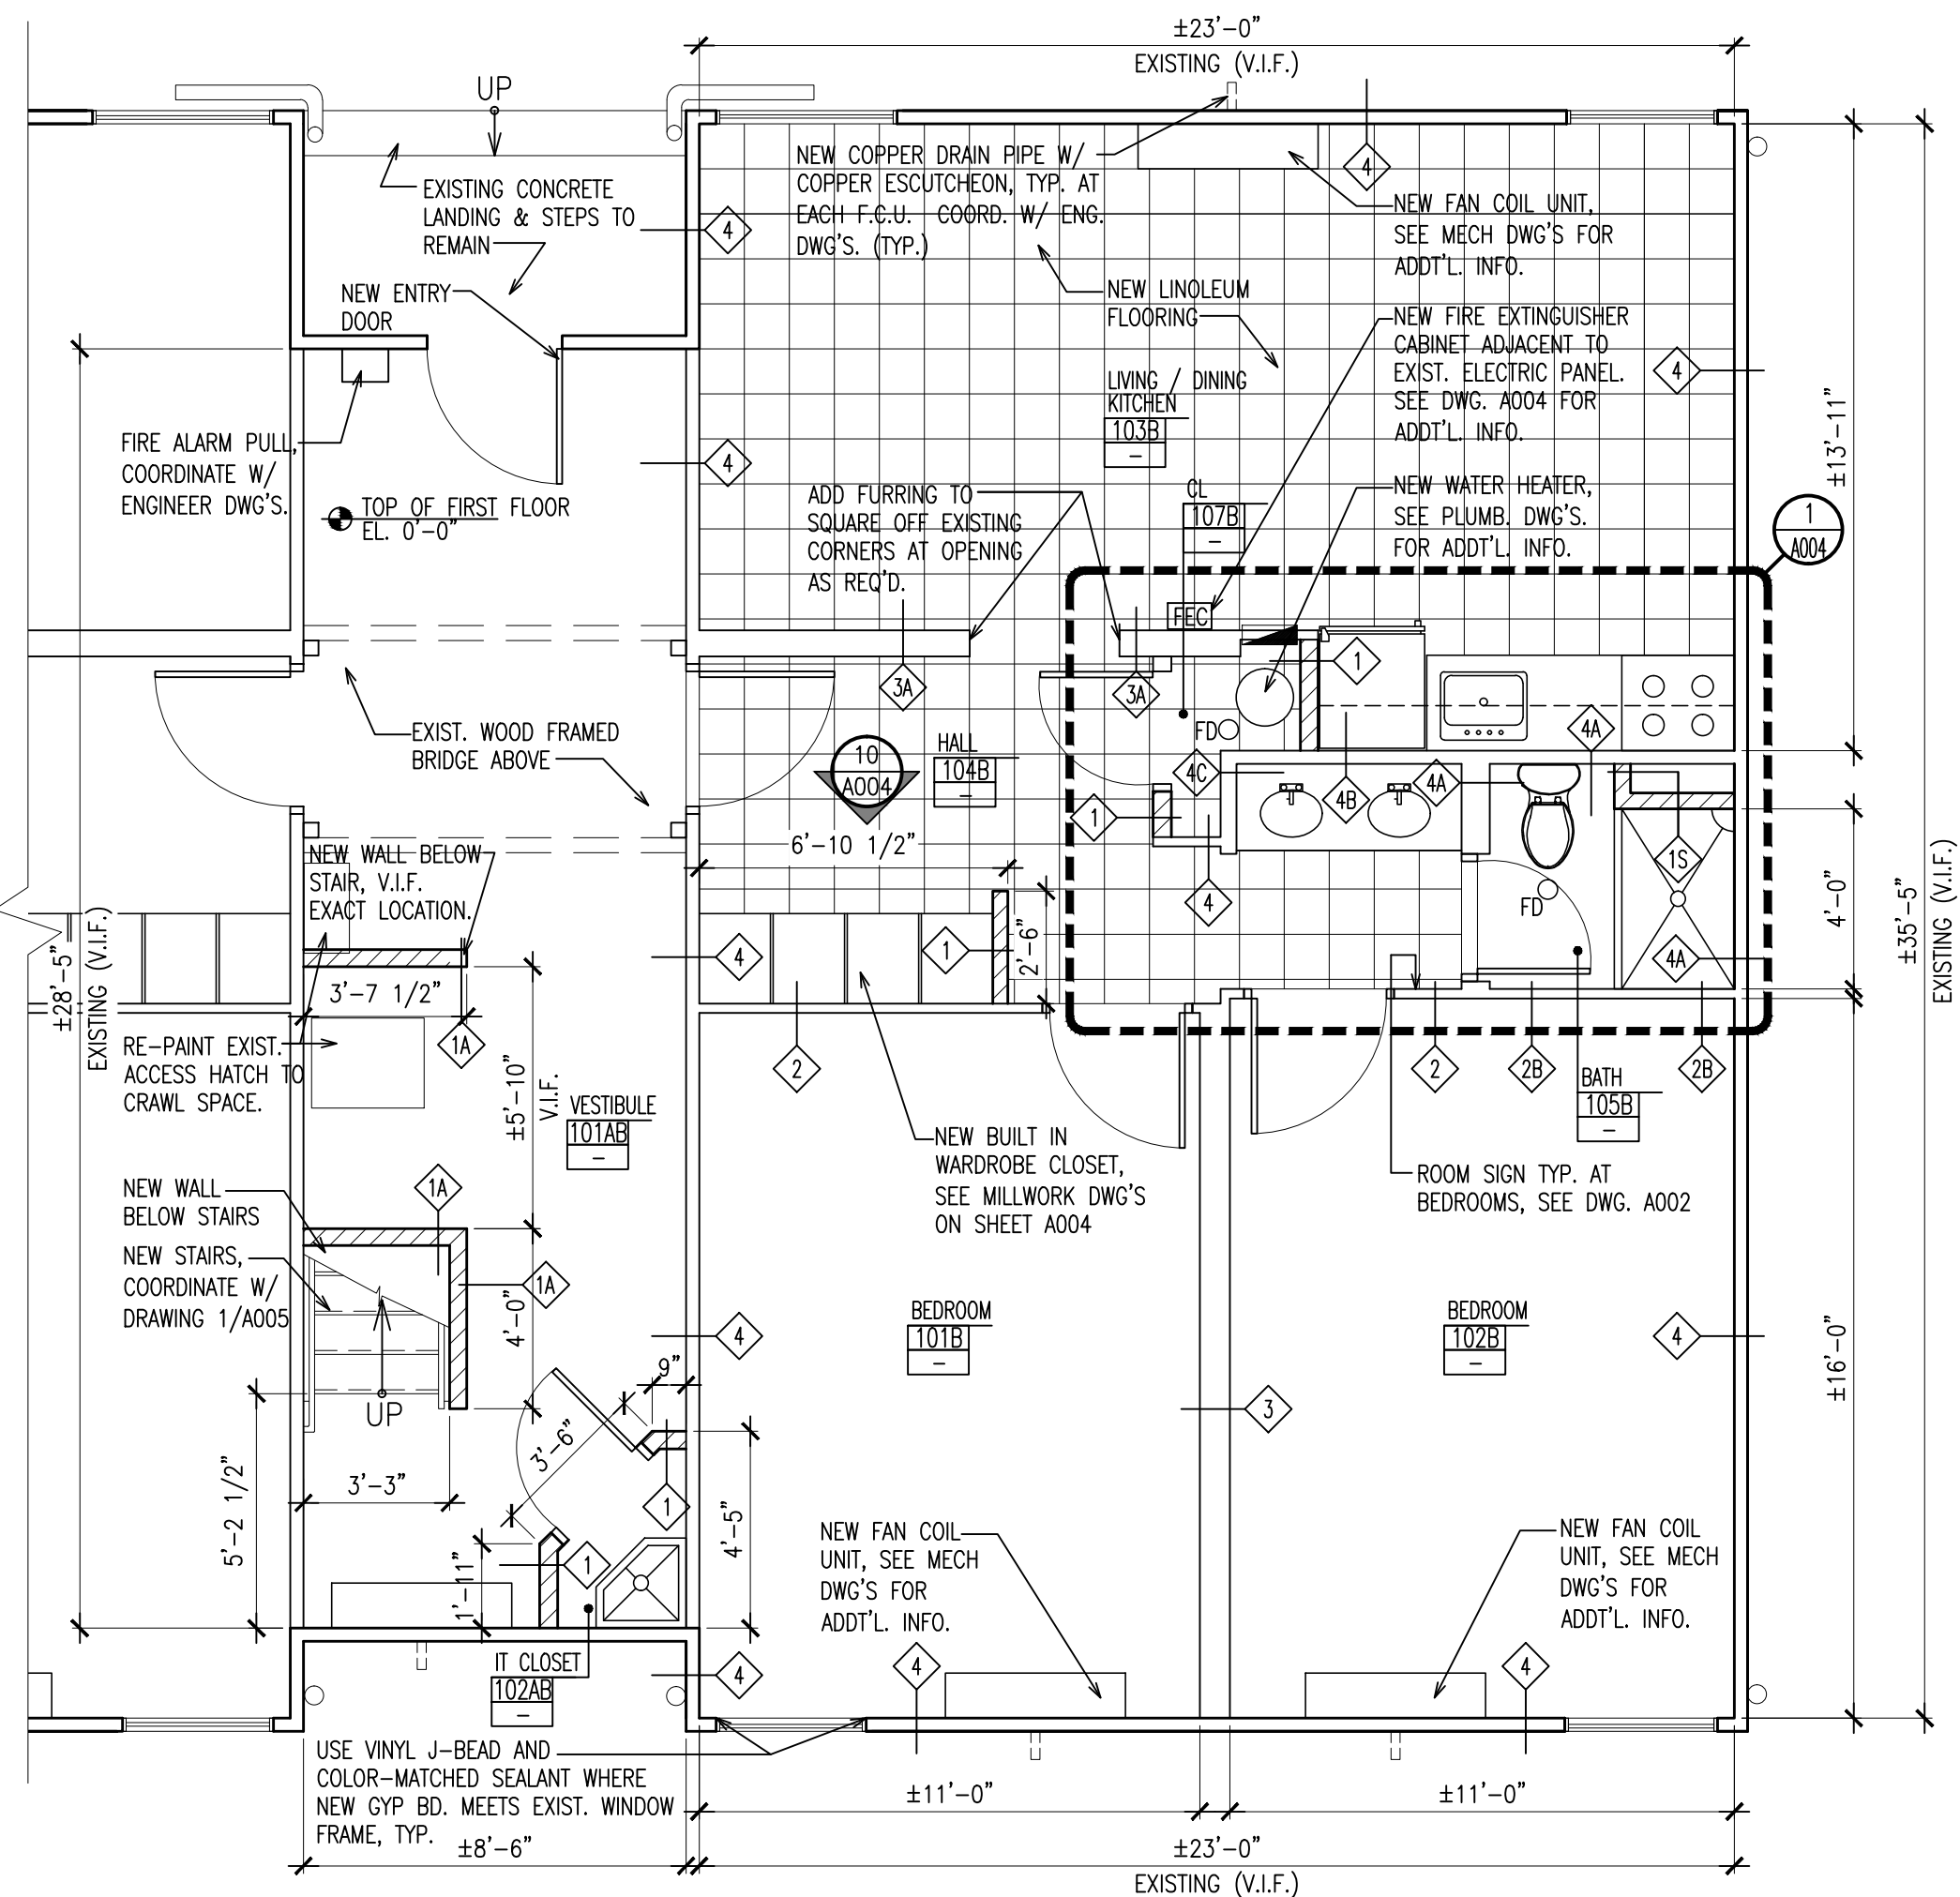

1 PARTIAL FIRST FLOOR ENLARGED PLAN  
SCALE: 1/4" = 1'-0"

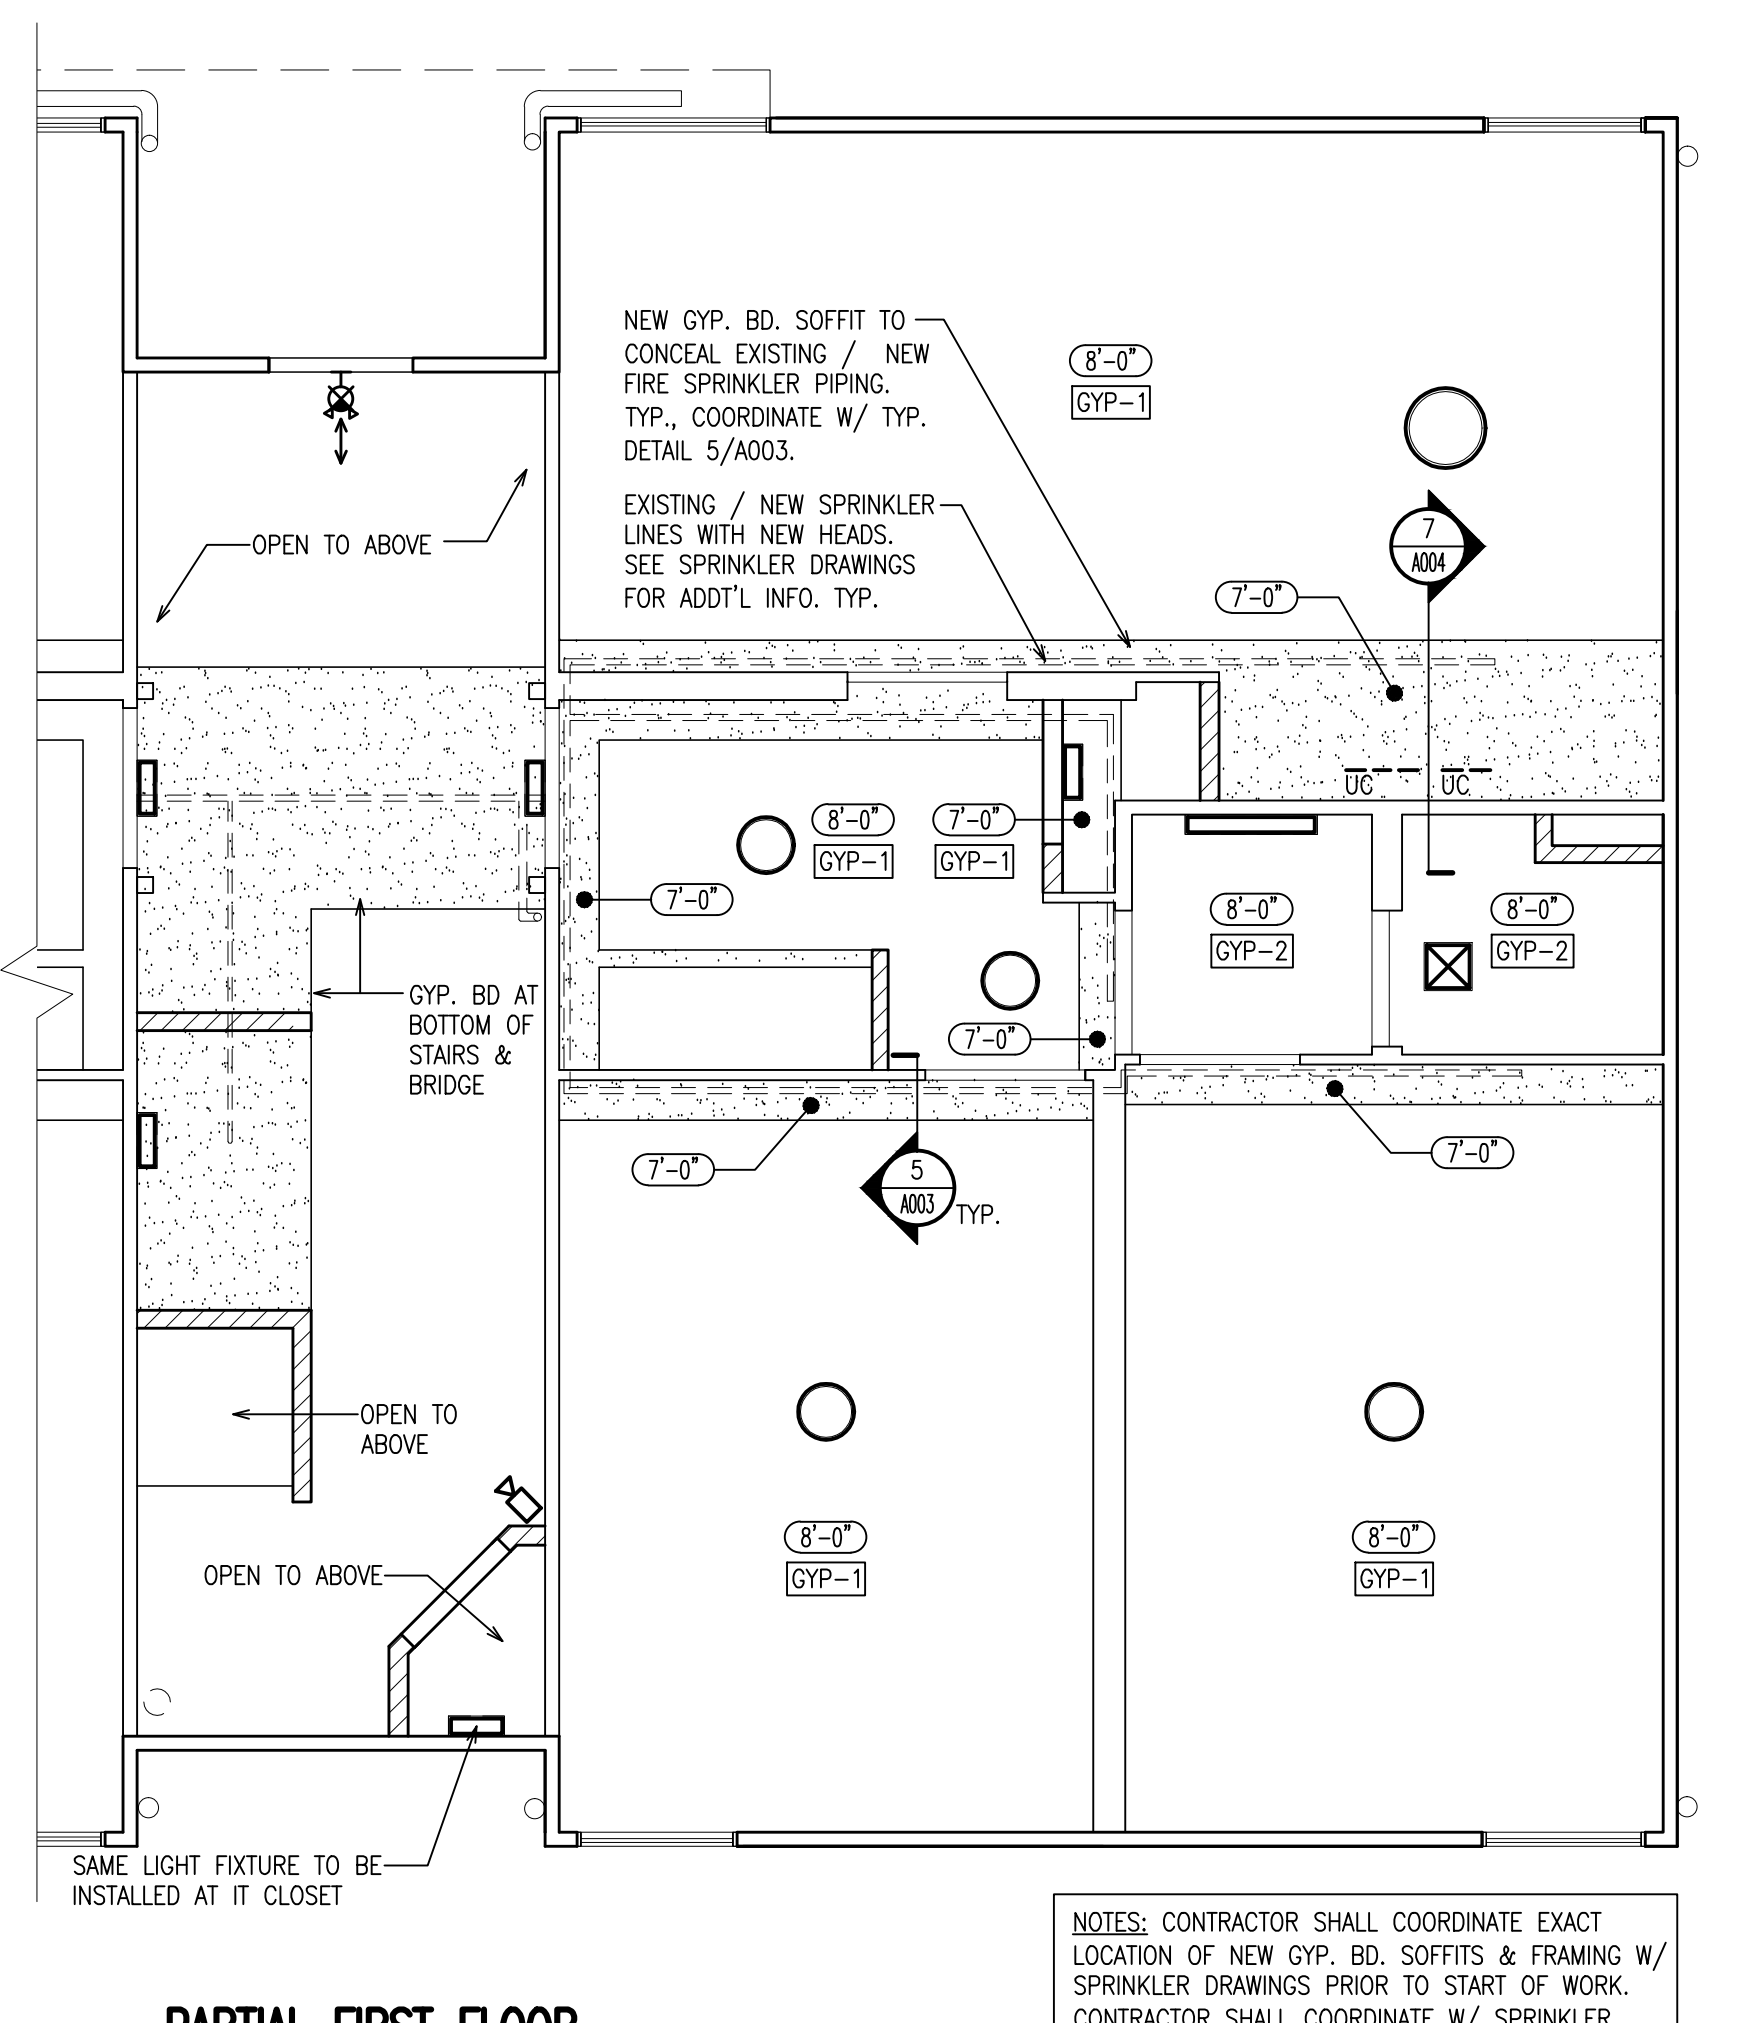

**3 PARTIAL FIRST FLOOR  
ENLARGED REFLECTED CEILING PLAN**  
SCALE: 1/4" = 1'-0"

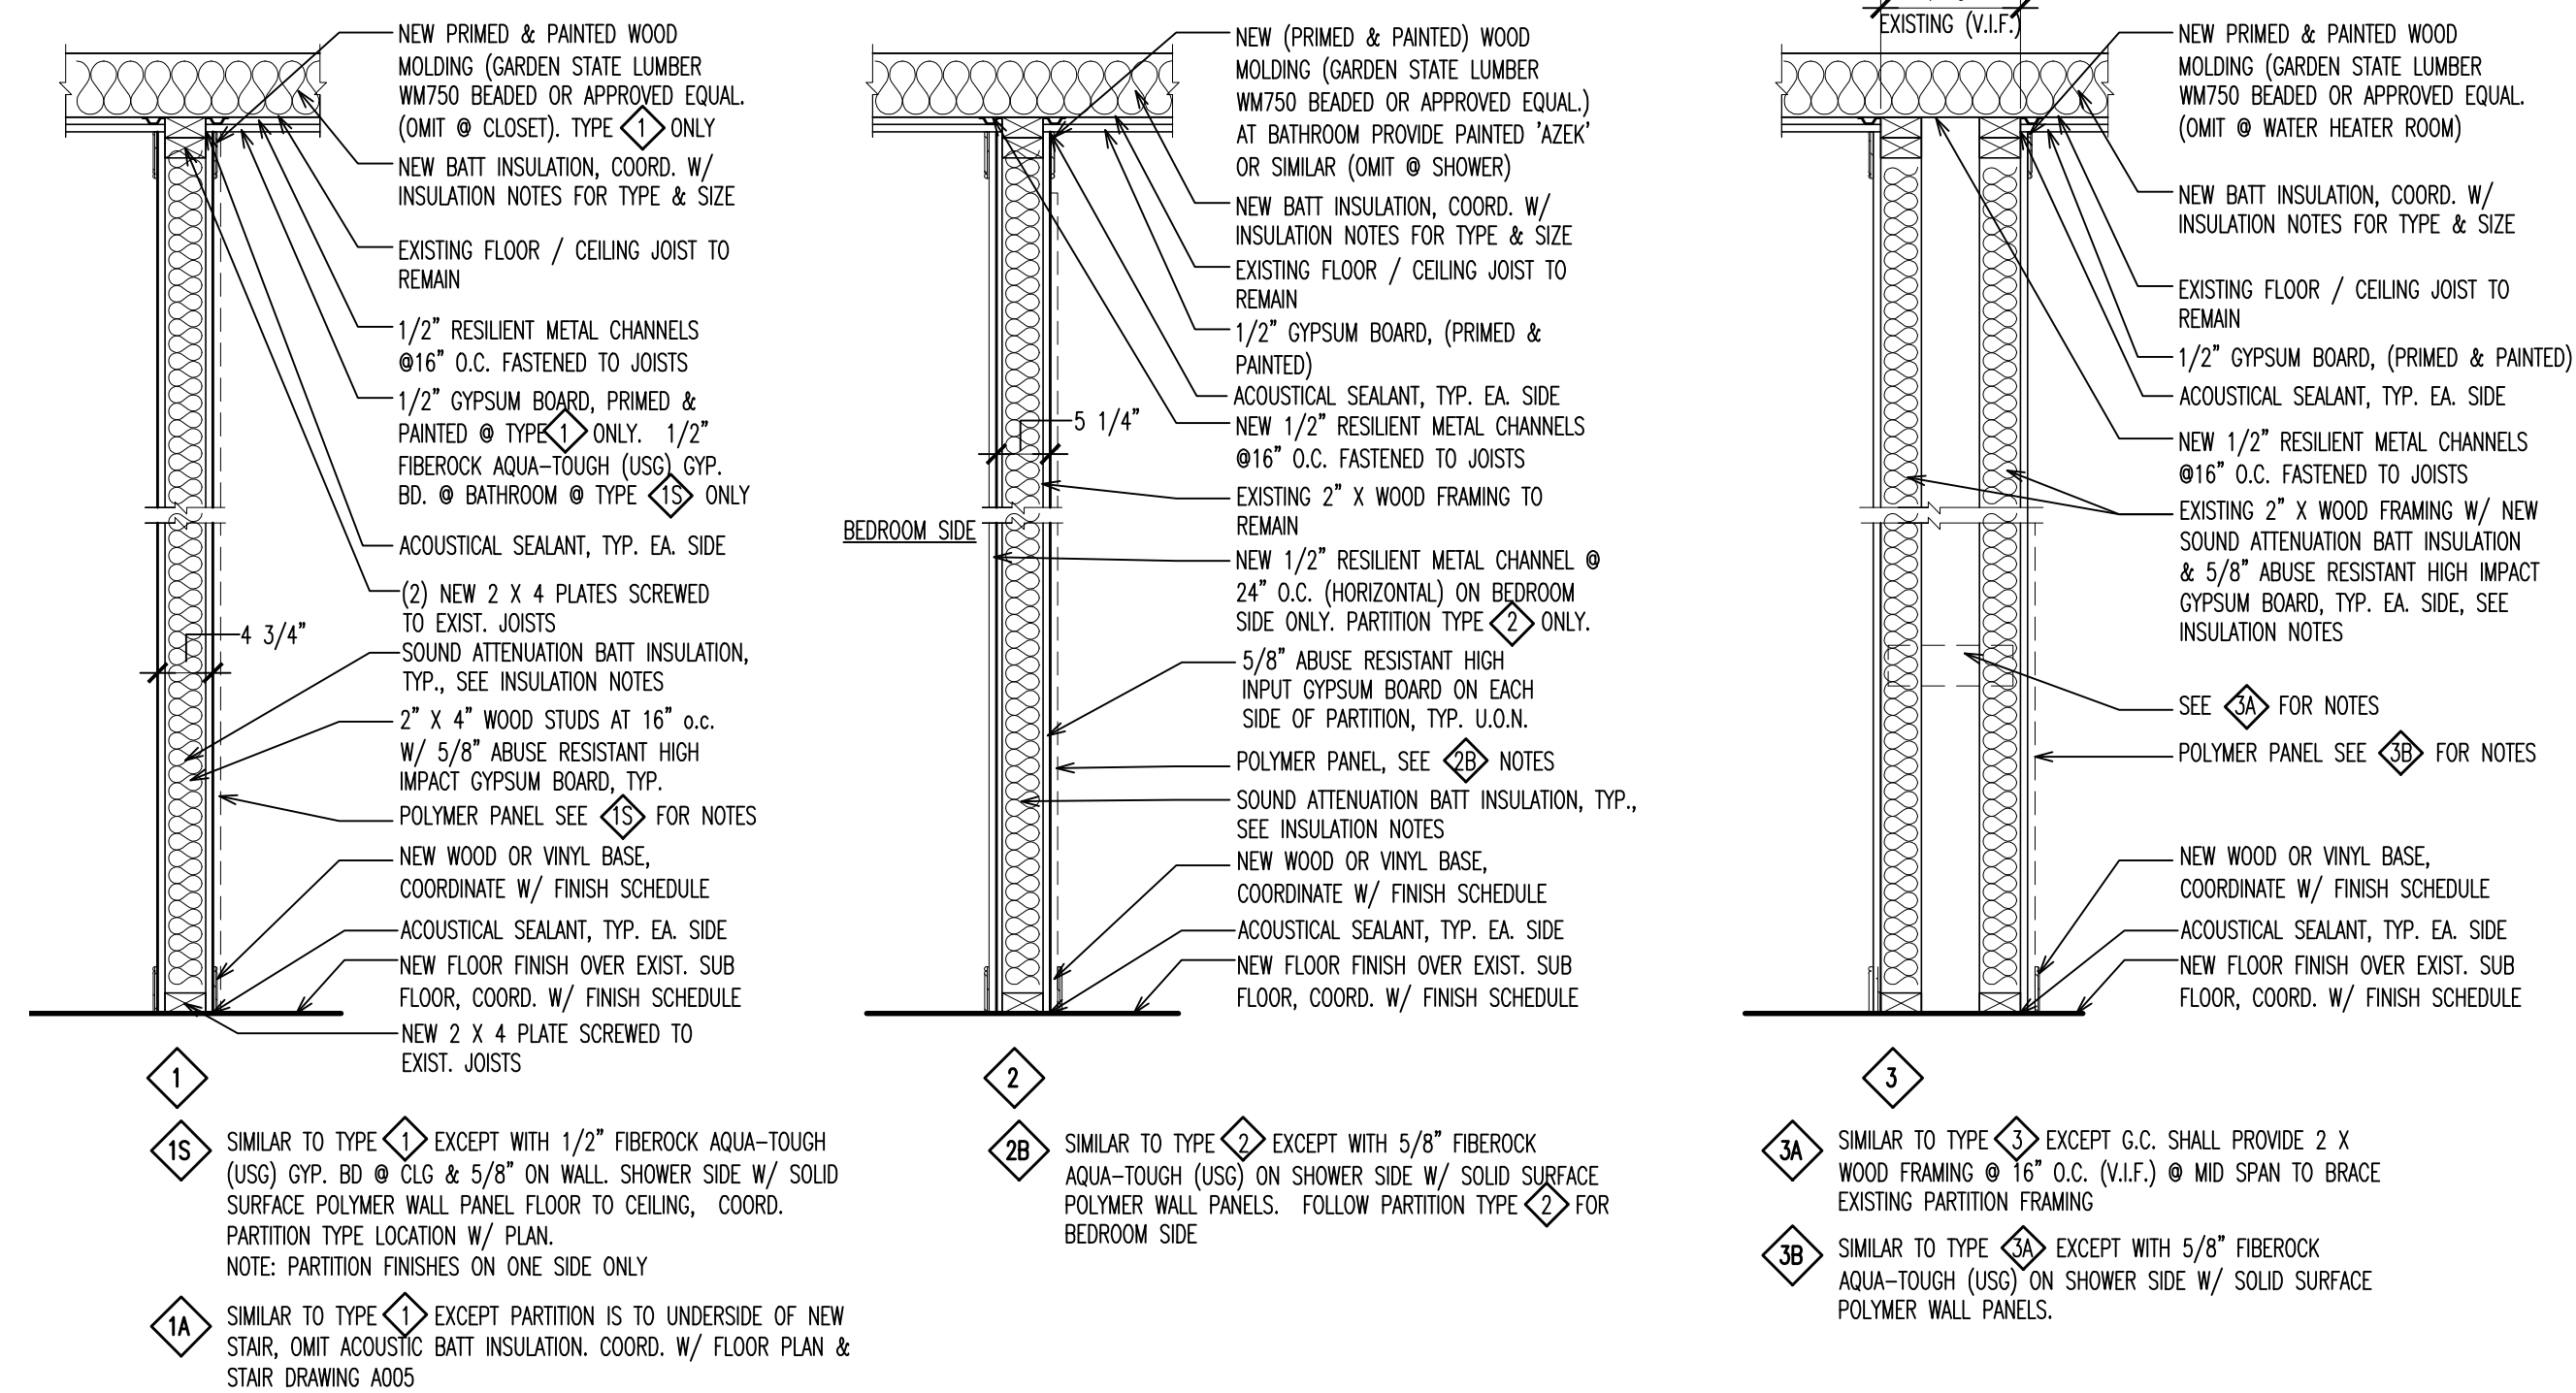

## PARTITION NOTES


1. REFER TO PLAN FOR ALL NEW PARTITION TYPE LOCATIONS.
2. TAPE & SPACKLE ALL JOINTS IN DRYWALL, INCLUDING ALL DRYWALL ABOVE THE CEILING.
3. AT PARTITIONS THAT REQUIRE SOUND ATTENUATION BLANKETS, CONTRACTOR SHALL CHALK PERIMETER W/ SEALANT & SEAL ALL PENETRATIONS INCLUDING PIPING, DUCT WORK, ELECTRICAL, BOXES, ETC.
4. BRACE ALL WOOD STUD PARTITIONS AT ALL LOCK SIDES OF DOORS, WHERE DOORS INTERFERE W/ STUDS GOING TO UNDER OF EXISTING STRUCTURE AND ADD BRACE FOR CEILING.
5. ALL PARTITIONS SUPPORTING MIRROR CABINETS AND/OR SHELVING SHALL HAVE WOOD STUD JOINTS @ 12" O.C. IN BAY OF 16" O.C.
6. PROVIDE CONTROL Joints @ 10' BD. PARTITIONS OVER 30 FT IN LENGTH AND AT ALL INTERSECTIONS OF COLUMNS & WHERE RECOMMENDED BY MANUFACTURER'S PRINTED STANDARDS.
7. Gypsum BOARD SHALL BE 5/8" THICK TYPE "X" BOARD WITH PLUSH MOUNTED ACCESS DOOR WHERE REQUIRED BY MECHANICALS.
8. GYPSUM BOARD NOTES:
  - A) AT ALL BATHROOM WALLS, 5/8" FIRE/RATED BRAND X-BOARD (USG), 5/8" FIRE/RATED PARTITIONS, 5/8" MOIST RESISTANT H-IMPACT GYPSUM BOARD FOR FIRST 8'-0", 5/8" TYPE "X" GYPSUM BOARD ABOVE AS REQ'D.
  - B) TYPE "X" GYPSUM BOARD JOINTS READY TO RECEIVE NEW FINISHES.
9. TAPE & SPACKLE NOTES FOR WALLS, CEILING / FLOORS ON DRAWING A003.
10. NEW WOOD BASE, FURNISHED & INSTALLED BY GC. SHALL BE "YUKON" KEDWOOD, COLONIAL BASE MOLDED PRIMED PINE, PAINTED WHITE TYP.

## INSULATION NOTES:

- G.C. TO FURNISH & INSTALL R-19 F.G. INSULATION BETWEEN ALL EXIST. FLOOR / CLG JOISTS BETWEEN 1ST & 2ND FLOOR THROUGHOUT THE ENTIRE BUILDING.
- IN ATTIC, G.C. TO FURNISH & INSTALL R-30 F.G. INSULATION OR 9" THICK BLOWN IN F.G. INSULATION. G.C. TO DETERMINE WHAT METHOD WILL BE USED
- AT EXTERIOR WALL, DEMISING UNIT WALLS & DEMISING BEDROOM WALLS ON ALL FLOORS AROUND THE ENTIRE PERIMETER OF THE BUILDING, G.C. TO INSTALL R-13 F.G. INSULATION W/ PAPER ON THE WARM SIDE.
- NOTE: CONTRACTOR SHALL INSTALL ARC WIRE BETWEEN INSULATION & FRAMING SUPPORTS AT CEILING / FLOOR & ATTIC, TYP.


**PARTITION TYPES**  
N.T.S.

### REFLECTED CEILING PLAN LEGEND

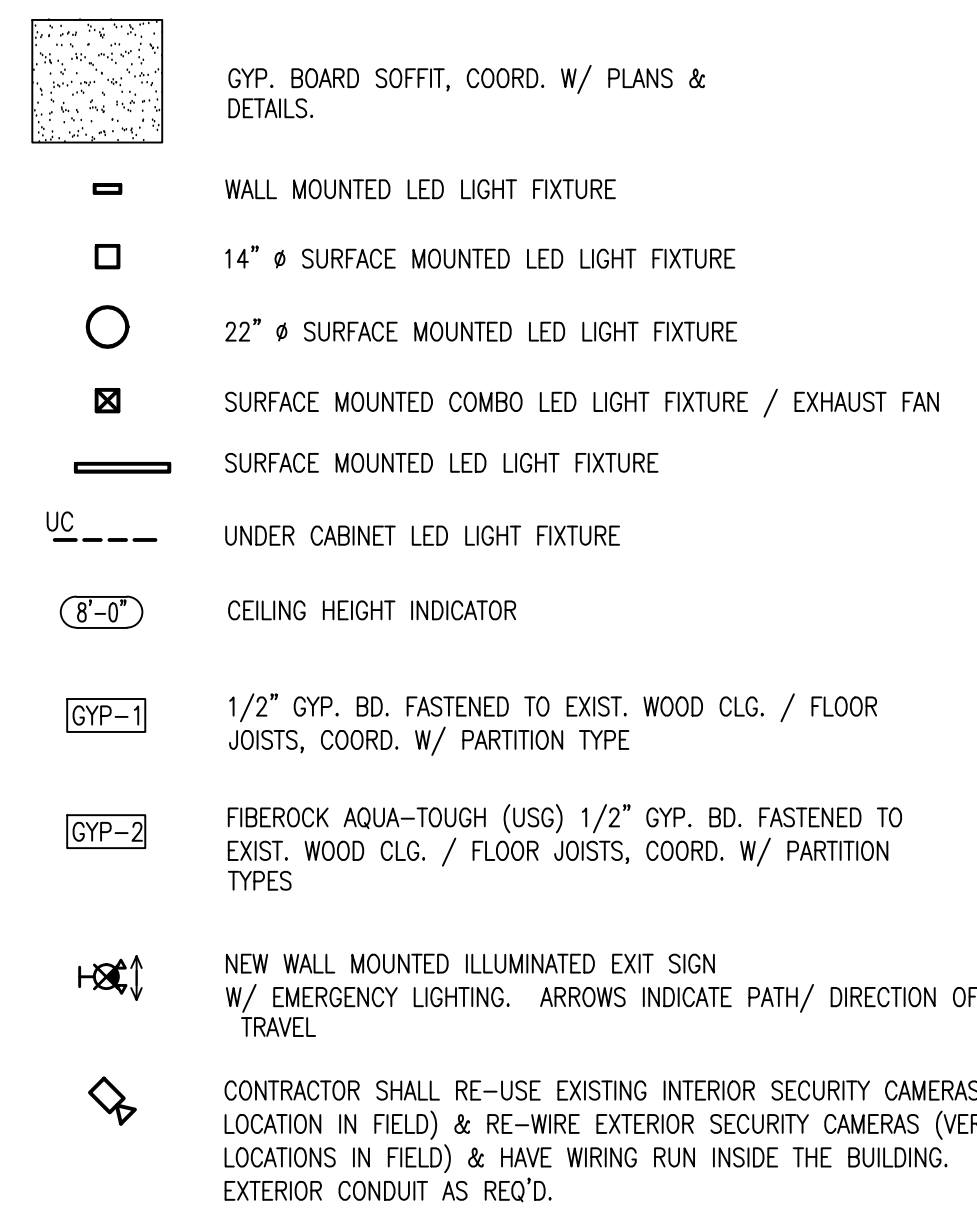

### REFLECTED CEILING PLAN GENERAL NOTES


1. FOR ADDITIONAL, GENERAL NOTES REFER TO DRAWING A000.
2. REFER TO CONSULTING ENGINEER'S DRAWINGS FOR ALL ADDITIONAL EXIT LIGHTS, EMERGENCY LIGHTS AND NIGHT LIGHT LOCATIONS.
3. ALL CONTRACTORS ARE TO FOLLOW LAYOUT ON ARCHITECTURAL DRAWINGS AND COORDINATE WITH OTHER TRADES.
4. ALL GYPSUM BOARD CEILING SYSTEMS SHALL COMPLY WITH BUILDING CODE.
5. THE LOCATION OF ELECTRICAL EQUIPMENT, ETC. IS APPROXIMATE AND IS SUBJECT TO MODIFICATION IN FIELD BY THE CONTRACTOR AND APPROVED BY ARCHITECT.
6. ELECTRICAL CONTRACTOR SHALL PROVIDE ALL TEMPORARY LIGHT AND POWER AS REQUIRED.
7. COORDINATE REFLECTED CEILING PLAN WITH ELECTRICAL DRAWINGS.
8. FOR LIGHT FIXTURE SPACES REFER TO ELECTRICAL DRAWINGS
9. TYPICAL CEILING FINISHES TOLERANCE: 2" VARIANCE PER ROOM. PROVIDE SHIMS AS REQ'D. BELOW RESILIENT MAT CHANGELS FASTENED TO WOOD FRAMING OF FIRST FLOOR CEILING AND AT WOOD FRAMING OF SECOND FLOOR CEILINGS SUCH THAT CEILING HORIZONTAL ELEVATION IS WITHIN TOLERANCE OF 1/8" VARIANCE MORE THAN 2" PER ROOM FROM LOW POINT OF CEILING GYPSUM WALL BOARD.
10. LOCATION OF EXISTING / NEW / MODIFIED SPRINKLER LINES & HEADS & SIDE WALL HEADS SHALL BE COORDINATED W/ SPRINKLER DRAWINGS PRIOR TO START OF WORK.
11. SEE INSULATION NOTES FOR WALLS, CEILINGS / FLOORS ON DRAWING A000.

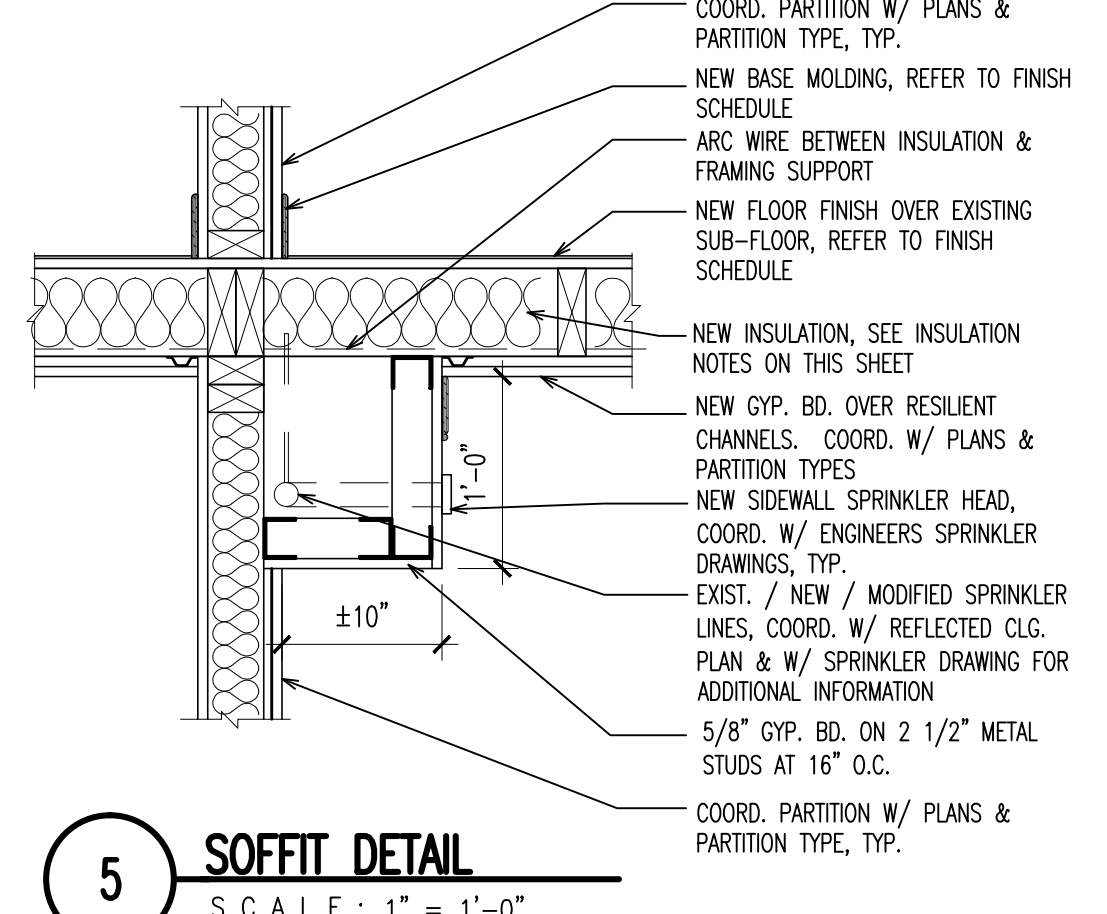

**5 SOFFIT DETAIL**  
SCALE: 1" = 1'-0"

Revisions		
Date	Issue	Description
06-03-15	1	ISSUED FOR CONSTRUCTION

### Key Plan

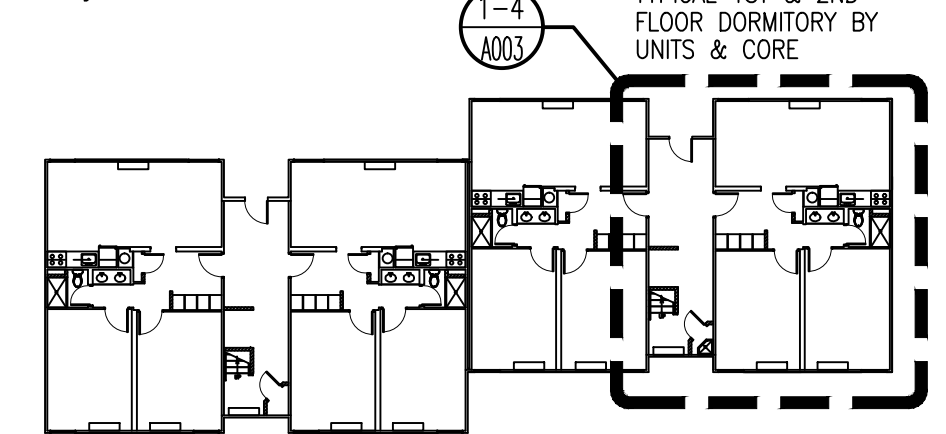

## Consultants



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## Project

INTERIOR RENOVATIONS  
AT THE  
SCIENCE HOUSE - H RESIDENCE



RAMAPO  
COLLEGE  
OF NEW JERSEY

505 Ramapo Valley Road  
Mahwah, New Jersey 07430-1880

## DCA PROJECT#

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Client



505 Ramapo Valley Road  
Mahwah, New Jersey 07430-1680



Fay W. Logan, AIA ☐

John M. Lignos, AIA ☐

Lorin J. Sonenshine, AIA ☒

Steven Napolitano, PE ☐

Cert./Lic. No. AI 109740			
Date	01-09-15	Scale	AS NOTED

Drawn By	DP	Checked By	DP
Dwg. Title			

## ENLARGED PLANS, NOTES, LEGEND & PARTITION TYPES

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Work Order No.
Dwg. No.

4698H A003