


MATCH
LINE

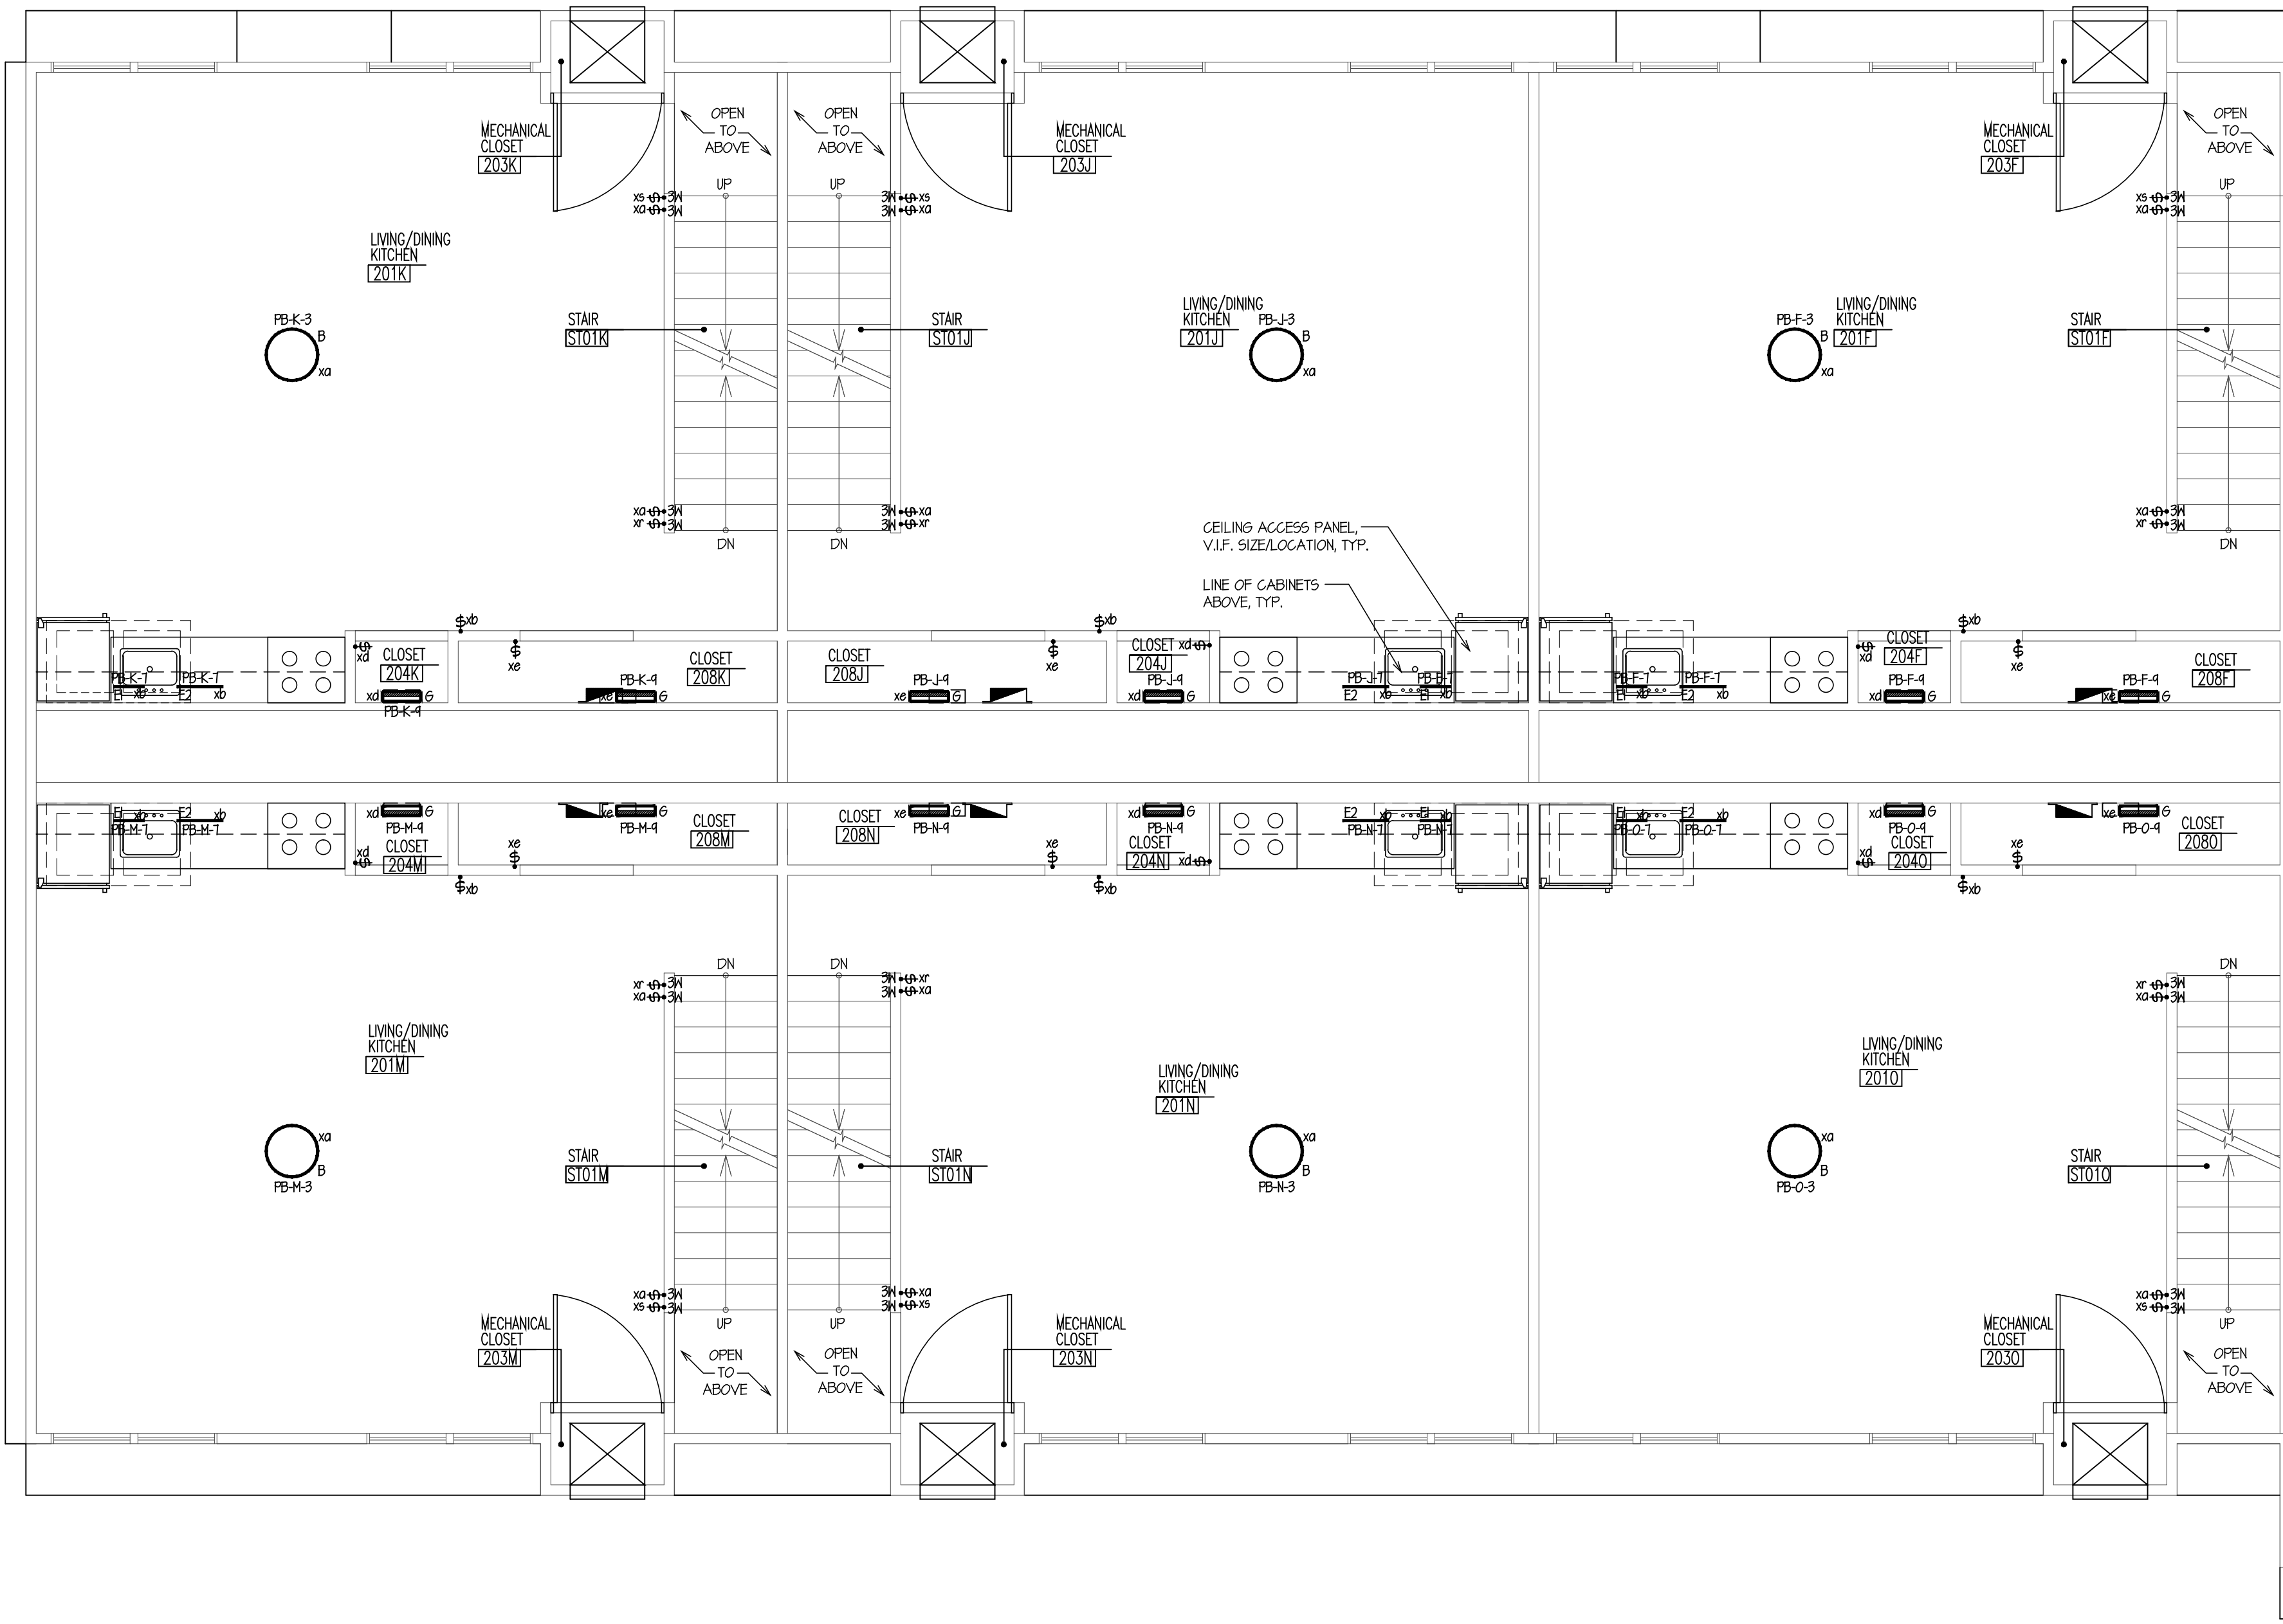

LIGHTING NOTES:

- WHERE EXISTING WIRING AND CIRCUITRY WHICH IS TO REMAIN IS LEFT EXPOSED BY DEMOLITION AND REMOVAL OF PARTITION AND/OR WING CEILING, RELOCATE SUCH WIRING TO MAINTAIN THE CIRCUIT CONTINUITY.
- WHERE EXISTING WIRING AND CIRCUITRY TO REMAIN IS LEFT SUBMERGED UP FROM FLOOR BY THE DEMOLITION AND REMOVAL OF PARTITIONS, RELOCATE SUCH WIRING AS REQUIRED TO MAINTAIN CIRCUIT CONTINUITY AND CUT BACK CONDUIT BELOW TOP OF FINISHED SLAB TO PERMIT PATCHING.
- WHERE EXISTING CIRCUITRY IS BEING UTILIZED FOR CONNECTION OF NEW LOAD OR BEING RETAINED FOR EXISTING LOADS AND SUCH CIRCUITRY IS NOT EXACTLY AS INDICATED ON PLANS, MAKE SUCH MODIFICATIONS AS MAY BE REQUIRED TO WIRING TO ACCORD WITH THE DESIGN INTENT.
- WHERE EXISTING LIGHTING EQUIPMENT, WIRING, ETC. IS INDICATED AS REMAINING AND SUCH ITEMS INTERFERE WITH THE INSTALLATION OR THE DEMOLITION WORK OF OTHER TRADES, DISCONNECT, REMOVE, AND RELOCATE TO AVOID CONFLICTS. REINSTALL AND RECONNECT SUCH ITEMS AS REQUIRED.
- WHERE EXISTING FIXTURES ARE BEING REMOVED AND SUCH REMOVAL DEVIATES THE CIRCUITRY TO FIXTURES WHICH ARE TO REMAIN, PROVIDE ALL NECESSARY MODIFICATIONS AND ADDITIONS TO WIRING AS REQUIRED TO RETAIN SERVICE AND SWITCH CONTROL FOR REMAINING FIXTURES.
- NUMBERS INDICATED FOR BRANCHED CIRCUITS ARE FOR GROUPING ONLY. ALL PANELBOARD DIRECTORIES ARE TO BE UPDATED FOR FUTURE REFERENCE.
- WHERE EXISTING FIXTURES ARE BEING REMOVED AND SUCH REMOVAL DEVIATES THE CIRCUITRY TO FIXTURES WHICH ARE TO REMAIN, PROVIDE ALL NECESSARY MODIFICATIONS AND ADDITIONS TO WIRING AS REQUIRED TO RETAIN SERVICE AND SWITCH CONTROL FOR REMAINING FIXTURES.


MATCH
LINE

SECOND FLOOR LIGHTING PLAN
SCALE: 1/4"=1'-0"

Revisions

Date	Issue	Description
06-03-15	1	ISSUED FOR CONSTRUCTION
11-16-15	2	REVISED PER NJDOCA ELECTRONIC STAMP

Key Plan

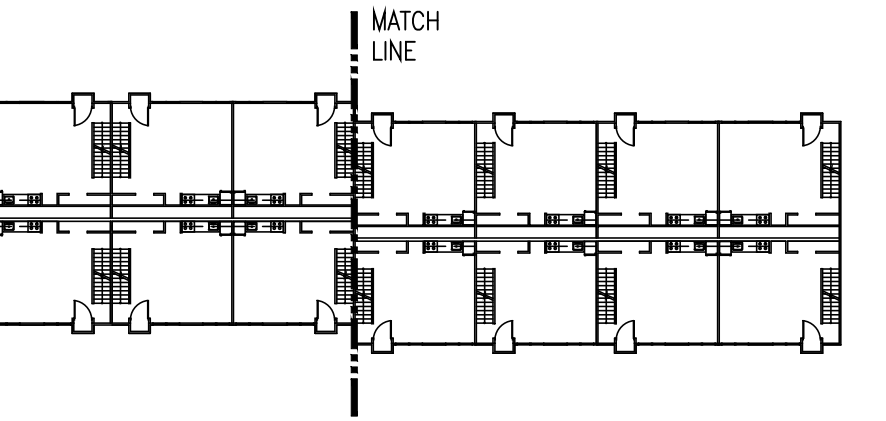

Consultants

LINWOOD ENGINEERING ASSOCIATES, P.A.

CONSULTING MECHANICAL & ELECTRICAL ENGINEERS

LEA 955 Lincoln Ave. 2001 Dupont Drive-Suite 150
Glen Rock, New Jersey Irvine, California
07452 92512
t: 201.857.3998 f: 714.424.0001
t: 201.857.3984 f: 714.424.0004
www.linwoodengineering.com

Project

INTERIOR RENOVATIONS
AT THE
TAMARACK - N RESIDENCE

RAMAPO COLLEGE
OF NEW JERSEY
505 Ramapo Valley Road
Mahwah, New Jersey 07430-1680

Client

RAMAPO COLLEGE
OF NEW JERSEY
505 Ramapo Valley Road
Mahwah, New Jersey 07430-1680

SNS Architects & Engineers, PC
1 PARAGON DRIVE, MONTVALE, NEW JERSEY, 07645
tel: 201.573.1767 fax: 201.573.0808 www.sns-arch-eng.com

Fay W. Logan, AIA
John M. Lignos, AIA
Lorin J. Sonenshine, AIA
Steven Napolitano, PE

Michael T. Davina, P.E.
NJ #48654
CT #0025779

Robert J. Hatch, P.E.
AR #13868
CA #E16118
CT #15318
FL #69560
MA #48516
NJ #35419
NY #019975
PA #036014-E

Cert./Lic. No.
Date 04-10-15 Scale AS NOTED
Drawn By MD Checked By SE

Dwg. Title
SECOND FLOOR LIGHTING PLAN

Work Order No. 4698N Dwg. No. E201