ADDENDUM NUMBER 1

PARTICULARS

- 1.01 DATE: April 7, 2015
- 1.02 PROJECT: Interior Renovations to the Mimosa G Residence

Ramapo College of New Jersey

1.03 SNS PROJECT NUMBER: 4698G

TO: PROSPECTIVE BIDDERS

- 2.01 This Addendum forms a part of the Contract Documents and modified the Bidding Documents dated March18, 2015 and the Addendum Number 1 issued April 7, 2015, with amendments and additions noted below.
- 2.02 Acknowledge receipt of this Addendum in the space provided in the Bid Form. Failure to do so may disqualify the bidder.
- 2.03 This Addendum consists of 3 pages, Addendum #1-1 to #1-3, and Revised drawings as listed below.

CHANGES TO THE DRAWINGS

- 3.01 ARCHITECTURAL DRAWINGS: (see revised drawings).
 - 1. DRAWING A000, COVER SHEET, GENERAL NOTES:
 - 1.1. Controlled Inspections notes have been added to Cover Sheet.
 - 1.2. Safety Plan Notes have been added to Cover Sheet.
 - 1.3. General Notes: #18, #22, #27, #29, #30, #32, #43; have been either revised or are new.
 - 2. DRAWING A001, BUILDING DEPARTMENT NOTES, EGRESS PLANS & PARTIAL DEMOLITION PLANS:
 - 2.1. Building Department Notes: Note 4. Applicable Regulations,
 - 2.1.1. A. NJUCC Act & Regulations; Note #1 has been revised to read" Current through all up to date revisions".
 - 2.1.2. B. N.J.A.C. 5:23-6 Rehabilitation Subcode, 2. The rehabilitation subcode references parts of the following model codes; letter 'H' has been removed.
 - 2.1.3. C. has been revised to read" Construction designed by Linwood Engineering Associates, PA".

- 2.2. Demolition Notes:
 - 2.2.1. Demolition Note #10 has been revised.
 - 2.2.2. Demolition Note #14 has been added to drawings.
- 2.3. Demolition Scope of Work / Clarification:
 - 2.3.1. Note #3, "Kitchen Cabinets & Appliances" has been added to note.
 - 2.3.2. Note #6, Door hardware demolition coordination note has been added to drawings.
- 2.4. Room Sign & Signage Notes have been added to the drawings.
- 3. DRAWING A002, FIRST & SECOND FLOOR PLANS, DOOR SCHEDULE & **DETAILS:**
 - 3.1. Door Schedule: Door #102IJ, Remarks: "Provide Flush Metal Louver".
 - 3.2. Door Schedule Notes; Note #12-C has been revised.
 - 3.3. Door Type 'A', Flush metal louver has been added as to drawing.
 - 3.4. Construction Plan Notes:
 - 3.4.1. Note #10-D has been removed.
 - 3.4.2. Note #11 has been revised.
 - 3.4.3. Note #12 has been revised.
 - 3.4.4. Note #13 has been added.
 - 3.5. Overall First Floor Plan 1/A002; I.T. Closet #102IJ: Note has been added" Furnish and install 4'x8'x3/4" F.T. plywood in IT Closet, painted black, exact location to be determined in field".
- 4. DRAWING A003, ENLARGED PLANS, NOTES, LEGEND & PARTITION TYPES:
 - 4.1. Partial First Floor Enlarged Plan 1/A003;
 - 4.1.1. Dimensions have been revised at Vestibule stair (see revised plans).
 - 4.1.2. New VCT Flooring has been replaced with "New Linoleum Flooring".
 - 4.2. Partition Types: Description for partition type 4C has been added.
 - 4.3. Partition Notes: Note #10 has been added to the drawings.
 - 4.4. Insulation Notes: first note has been revised.
- 5. DRAWING A004, ENLARGED PLAN, MILLWORK, DETAILS & EQUIP. SCHEDULE:
 - 5.1. Equipment Schedule:
 - 5.1.1. Mark & Description #29 have been removed (Vinyl Composite Tile Flooring).
 - 5.1.2. Mark #28, has been revised, it is no longer an alternate in kitchen area.
 - 5.2. Enlarged Bathroom & Kitchen Plan: Mark #29 has been replaced with Mark #28.
 - 5.3. Cabinet Sections #7, #8 & Vanity Section #9: VCT finish flooring note has been replaced with" Linoleum finish flooring".

- 6. DRAWING A005, STAIR PLAN & DETAILS & FINISH SCHEDULE:
 - 6.1. Enlarged Stair Plan: Dimensions have been changed at stair, see revised plans.
 - 6.2. Stair Section 2/A005, Stair Detail 3/A005, Stair Elevation 4/A005 & Stair Guardrail Detail 6/A00, have been revised to match stair dimension revisions, see plans.
 - 6.3. Finish Schedule:
 - 6.3.1. Revisions have been made to floor & Base columns, see revised plan.
 - 6.3.2. Living, Dining, Kitchen remarks column, remark has been omitted.
 - 6.3.3. Finish Schedule Notes: Note #6 & #7 have been added, see revised plans.
- 4.01 <u>M.E.P. DRAWINGS: (see revised drawings).</u>
 - 1. DRAWING E100, ELECRICAL NOTES, SPECIFICATIONS AND SYMBOLS:
 - 1.1. Added note indicating that all demolition work is by others under separate contract and filed under separate DCA permit application.
 - DRAWING E200, FIRST & SECOND FLOOR ELECTRICAL DEMOLITION NOTES:
 - 2.1. Revised Key Note #4 to indicate new security cameras to be furnished and installed by others.
 - 2.2. Added power to new exhaust fan EF-1.
 - 3. DRAWING E300, ENLARGED FIRST &SECOND FLOOR ELECTRICAL PLANS:
 - 3.1. Added note indicating that all demolition work is by others under separate contract and filed under separate DCA permit application.
 - 3.2.
 - 4. DRAWING M001, HVAC NOTES, DETAILS, & SYMBOLS:
 - 4.1. Revised "HVAC Symbols for Alteration Work".
 - 5. DRAWING M100. FIRST & SECOND FLOOR HVAC PLANS:
 - 5.1. Added exhaust fan EF-1 to IT Closet, key notes and associated fan schedule.
 - 6. DRAWING M200, ENLARGED FIRST & SECOND FLOOR HVAC PLANS:
 - 6.1. Added note indicating that all demolition work is by others under separate contract and filed under separate DCA permit application.
 - 6.2. Removed unit ventilator from "Enlarged Second Floor HVAC Plan" located in Bridge 201GH.
 - DRAWING P200, ENLARGED FIRST & SECOND FLOOR PLUMBING PLANS:
 - 7.1. Added note indicating that all demolition work is by others under separate contract and filed under separate DCA permit application.

End of Addendum #1


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FOR REMOVAL & RE-CONNECT

UNIT UPON REPLACEMENT.

FIRST FLOOR ELECTRICAL DEMOLITION PLAN SCALE: 1/8"=1'-0"

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SECOND FLOOR ELECTRICAL DEMOLITION PLAN SCALE: 1/8"=1'-0"

ELECTRICAL DEMOLITION NOTES:

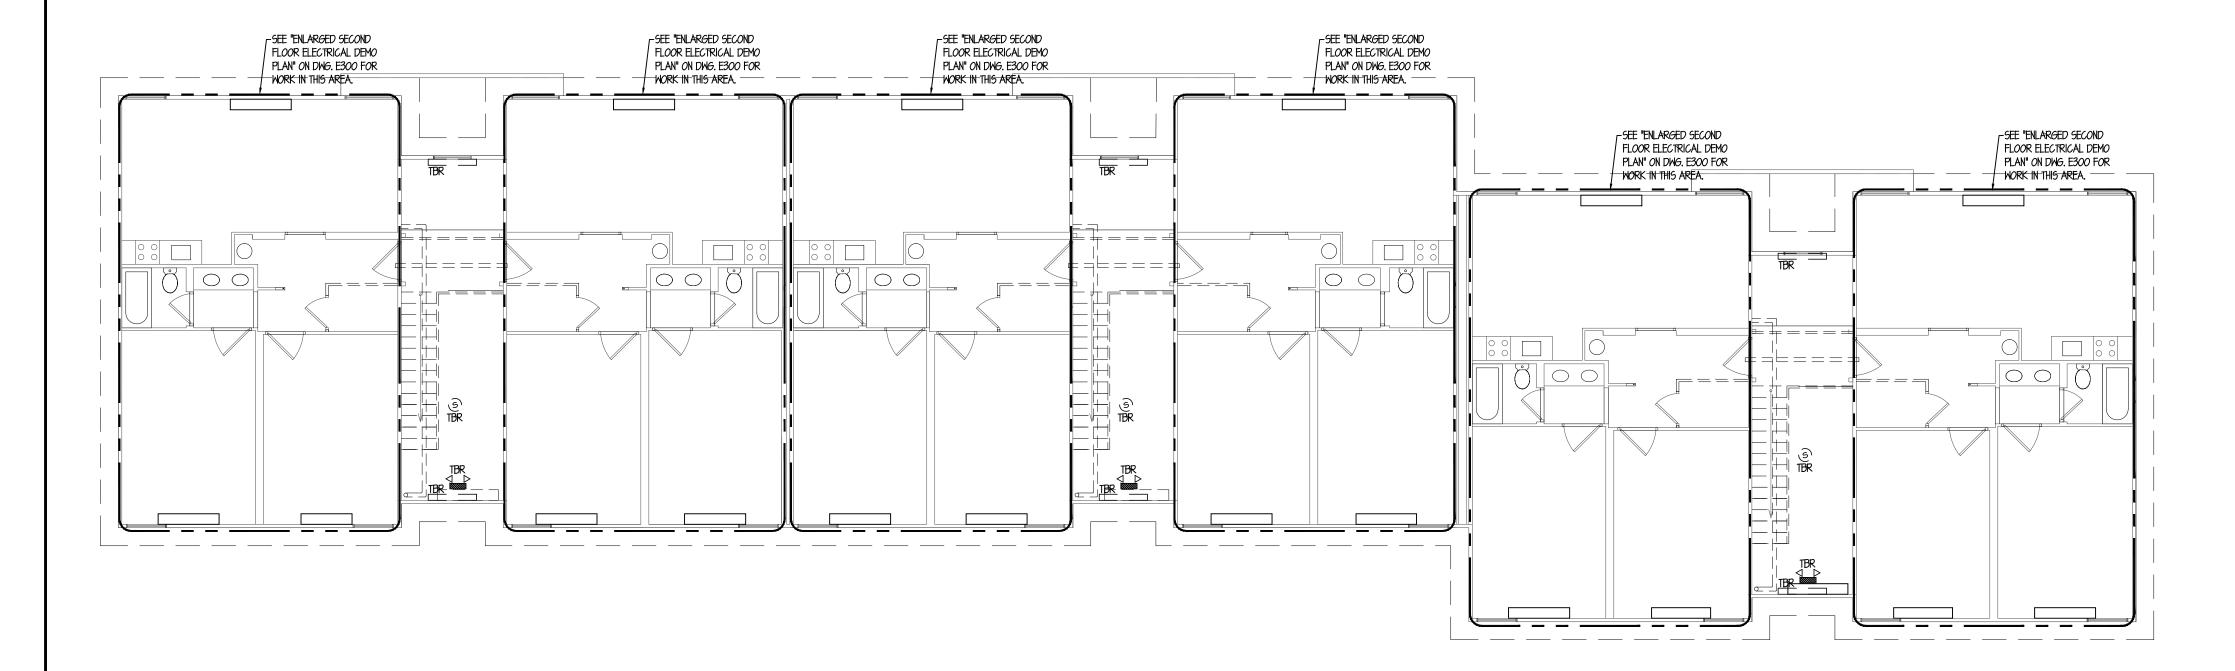I. DO NOT CONSIDER DEMOLITION AND ALTERATION NOTES TO BE ALL INCLUSIVE. IT IS THE CONTRACTOR'S RESPONSIBILITY TO INSPECT AND ASSESS EACH SPACE, AND TO FULFILL THE INTENT OF THE WORK INDICATED BY THE CONTRACT DOCUMENTS. VERIFY ALL DIMENSIONS WITHIN THE CONTRACT LIMITS, BRING DEVIATIONS FROM THE CONTRACT DOCUMENTS

NECESSITATED BY FIELD CONDITIONS TO THE ATTENTION OF CONTRACTOR SHALL DISCONNECT AND MAKE SAFE ALL AREAS PRIOR TO GENERAL DEMOLITION BY THE GENERAL CONTRACTOR, THIS SHALL INCLUDE ALL MECHANICAL EQUIPMENT, CONTROL SYSTEMS AND ACCESSORIES, ELECTRICAL

CONTRACTOR SHALL REFER TO MECHANICAL DRAWINGS FOR MECHANICAL EQUIPMENT REQUIRING DISCONNECT/DEMOLITION. 3. CONTRACTOR TO PROVIDE TEMPORARY LIGHTING & POWER IN AREA OF WORK. TEMPORARY LIGHTING IS TO REMAIN AT COMPLETION OF PROJECT. TEMPORARY LIGHTING SHALL PROVIDE A MINIMUM OF 30 FOOTCANDLES THROUGHOUT AREA

4. DO ALL NECESSARY DEMOLITION AND REMOVAL OF EXISTING LIGHTING, EXISTING FIRE ALARM SYSTEM AND ELECTRICAL EQUIPMENT AS REQUIRED. 5. DEMOLITION TO BE PERFORMED AFTER NORMAL WORKING

HOURS IF REQUIRED BY THE OWNER. 6. REPOUTE AND RECONNECT ALL CIRCUITING TO EXISTING LOADS WHICH ARE TO REMAIN IF SAME IS DISTURBED BY DEMOLITION WORK. PROVIDE NEW HOME RUNS, IF REQUIRED.

7. CONDUITS COMING UP OUT OF FLOOR SLAB WHICH ARE TO BE

REMOVED SHALL BE CUT BACK BELOW TOP OF FINISHED SLAB TO PERMIT PATCHING. 8. DISCONNECT AND REMOVE ALL EXISTING WIRING AND EXPOSED CONDUITS NOT BEING RETAINED OR REUSED. 9. REMOVE ALL DEVICES AND ASSOCIATED WIRING AND CONDUITS

FROM EXISTING OUTLETS, SWITCHES, FIRE ALARM DEVICES, ETC. BEING REMOVED TO PERMIT PATCHING OVER THE ARCHITECTURAL SURFACE. IO. WHERE EXISTING WIRING AND CIRCUITRY WHICH IS TO REMAIN IS

LEFT EXPOSED BY DEMOLITION AND REMOVAL OF PARTITION

AND/OR HUNG CEILINGS, REROUTE SUCH WIRING TO MAINTAIN THE CIRCUIT CONTINUITY. II. WHERE EXISTING LIGHTING, EQUIPMENT, WIRING, ETC. IS INDICATED AS REMAINING AND SUCH ITEMS INTERFERE WITH THE INSTALLATION OR THE DEMOLITION WORK OF OTHER TRADES, DISCONNECT, REMOVE, AND RELOCATE TO AVOID CONFLICTS.

REINSTALL AND RECONNECT SUCH ITEMS AS REQUIRED. WHERE EXISTING LIGHTING FIXTURES AND DEVICES ARE BEING REMOVED AND SUCH REMOVAL DISTURBS THE CIRCUITRY TO LIGHTING FIXTURES AND DEVICES WHICH ARE TO REMAIN, PROVIDE ALL NECESSARY MODIFICATIONS AND ADDITIONS TO

WIRING AS REQUIRED TO RETAIN SERVICE AND SWITCH 13. RELOCATE EXISTING ACTIVE OUTLET BOXES, JUNCTION BOXES, ETC., WHICH ARE RENDERED INACCESSIBLE BY NEW CONSTRUCTION.

14. ALL EXISTING BRANCH CIRCUIT WIRING FROM RESIDENTIAL TENANT PANELS SHALL BE REMOVED.


ALL DEMOLITION WORK IS BY OTHERS UNDER SEPARATE CONTRACT AND FILED UNDER SEPARATE DCA PERMIT.

Revisions

Description

03-06-15 ISSUED FOR DCA FILING 03-18-15 ISSUED FOR BIDDING 03-27-15 ISSUED FOR DCA FILING & CONSTRUCTION 04-07-15 ISSUED FOR ADDENDUM #1

Key Plan

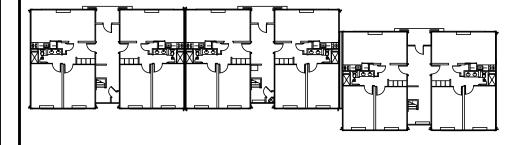

Consultants

LINWOOD ENGINEERING ASSOCIATES, P.A.

CONSULTING MECHANICAL & ELECTRICAL ENGINEERS 955 Lincoln Ave. 2301 Dupont Drive-Suite 150 Glen Rock, New Jersey 07452 92612




www.linwoodengineering.com

INTERIOR RENOVATIONS AT THE MIMOSA - G RESIDENCE




DCA PROJECT# 9071-15

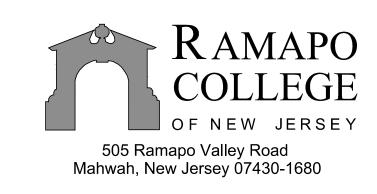



Fay W. Logan, AIA John M. Lignos, AIA Lorin J. Sonenshine, AIA

Steven Napolitano, PE O

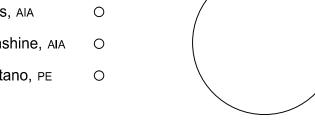

Scale AS NOTED

Cert./Lic. No.

Checked By 56 FIRST & SECOND FLOOR ELECTRICAL DEMOLITION PLANS


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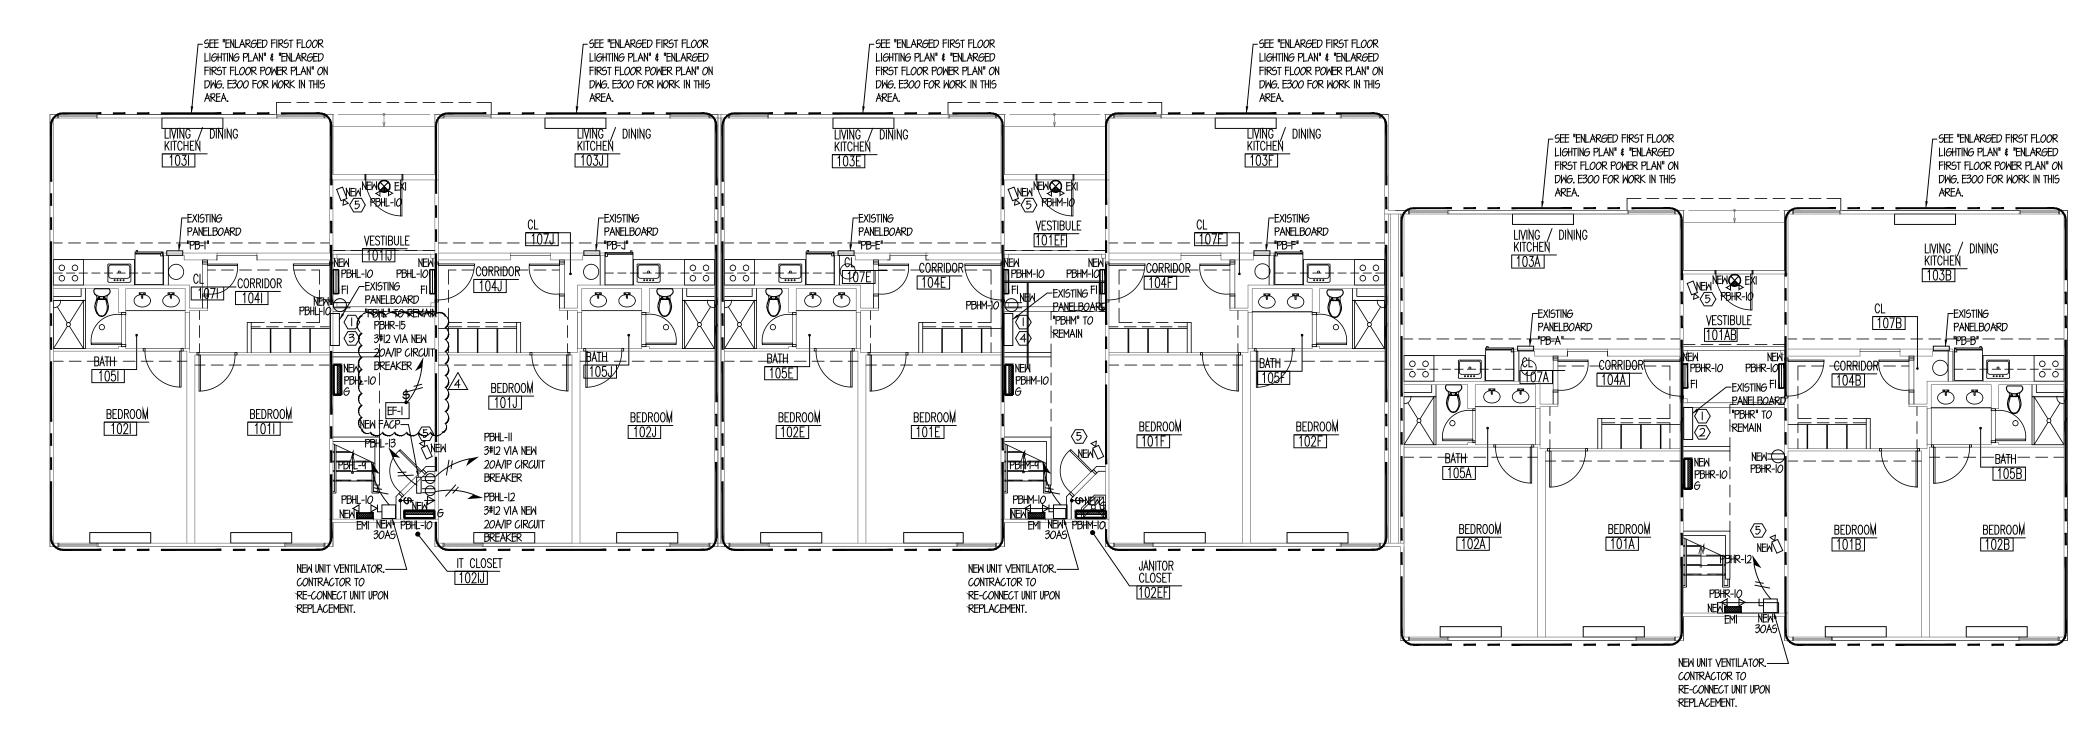
Michael T. Davina, P.E. Robert J. Hatch, P.E. NJ #48654 CT #0025779 CA #E16118

MA #48516 NJ #30419 NV #019975 NY #56608


PA #036014-E



CRAWL SPACE ELECTRICAL PLAN SCALE: 1/8"=1'-0"

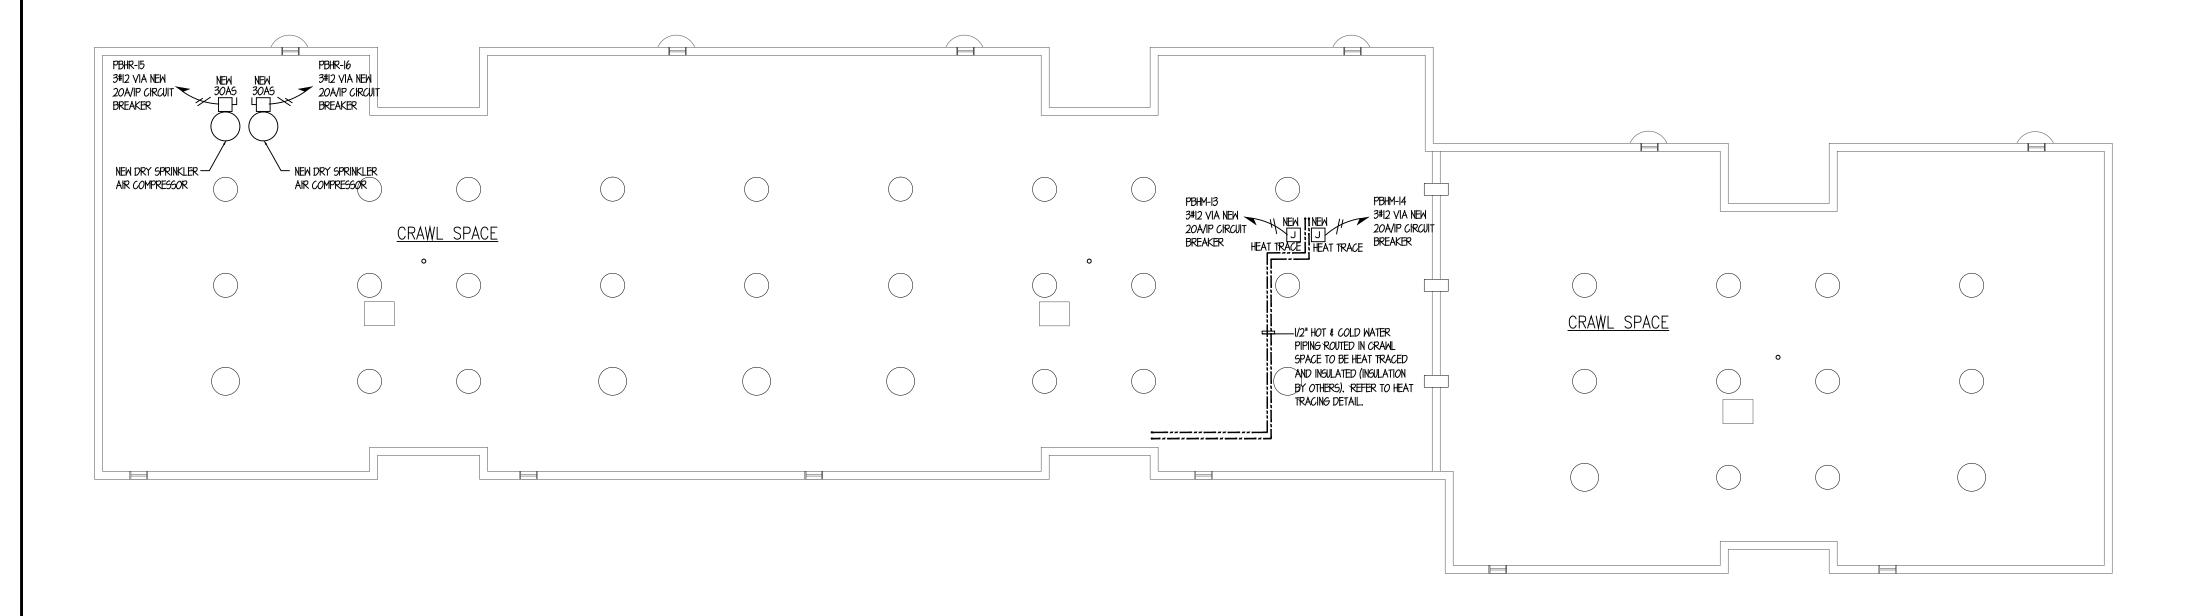

FIRST FLOOR ELECTRICAL PLAN SCALE: 1/8"=1'-0"

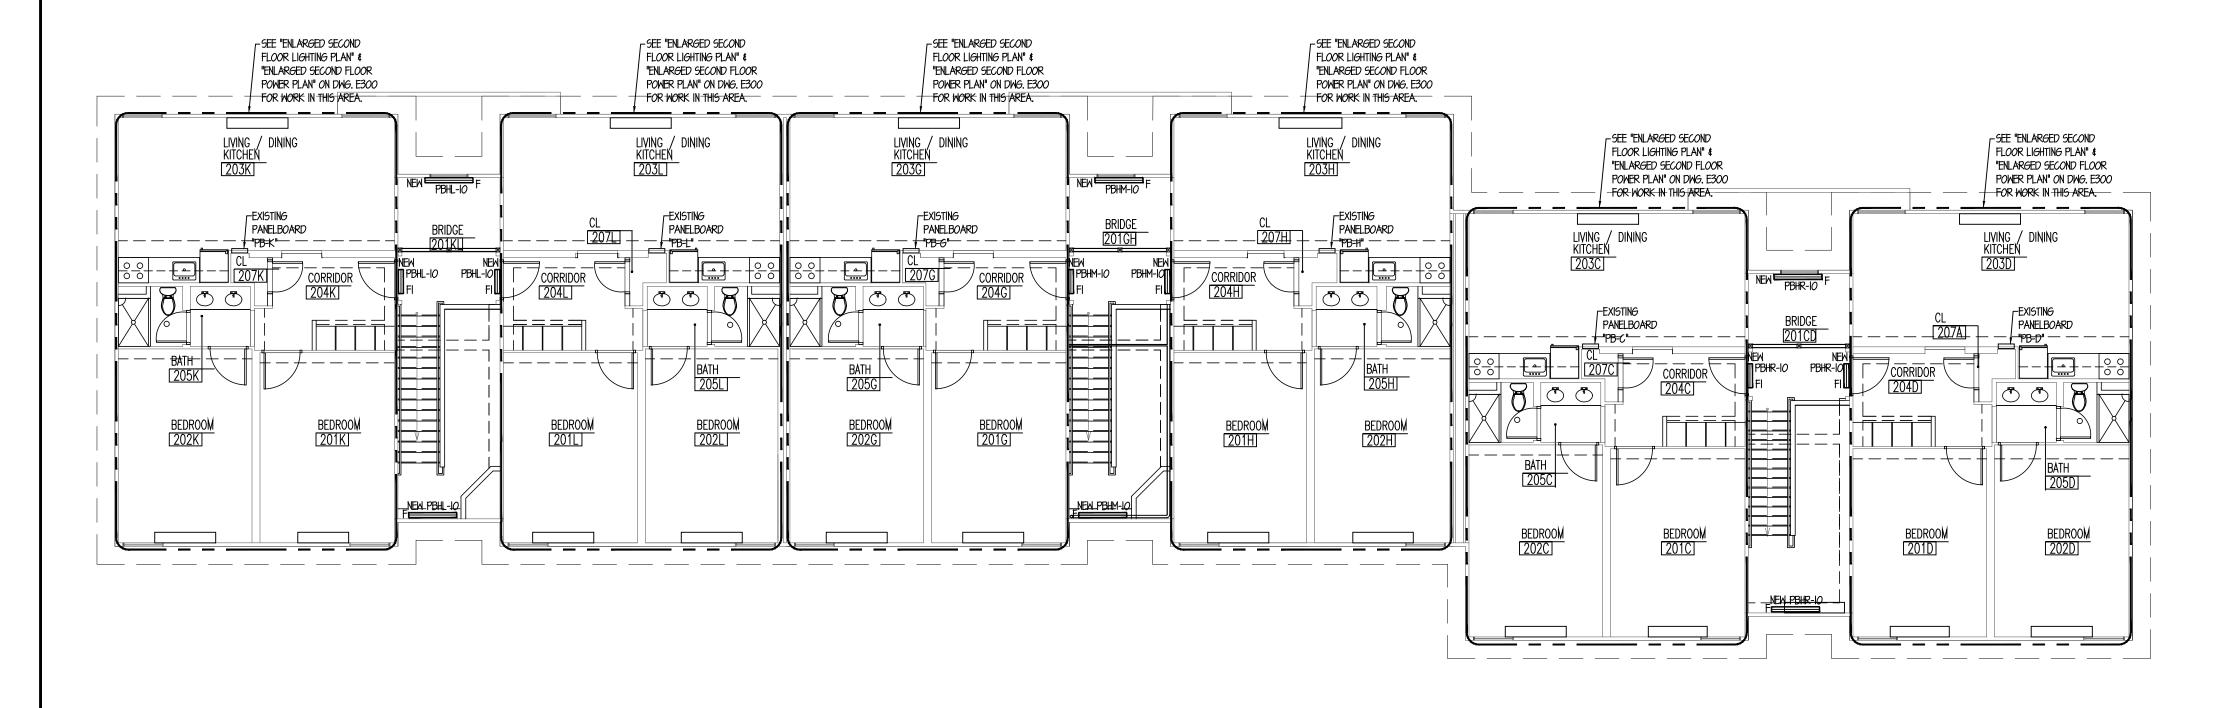

SECOND FLOOR ELECTRICAL PLAN SCALE: 1/8"=1'-0"

LIGHTING NOTES:

- WHERE EXISTING WIRING AND CIRCUITRY WHICH IS TO REMAIN IS LEFT EXPOSED BY DEMOLITION AND REMOVAL OF PARTITION AND/OR HUNG CEILINGS, REPOUTE SUCH WIRING TO MAINTAIN THE CIRCUIT CONTINUITY.
- WHERE EXISTING WIRING AND CIRCUITRY TO REMAIN IS LEFT STUBBED UP FROM FLOOR BY THE DEMOLITION AND REMOVAL OF PARTITIONS, REPOUTE SUCH WIRING AS REQUIRED TO MAINTAIN CIRCUIT CONTINUITY AND CUT BACK CONDUIT BELOW TOP OF FINISHED SLAB TO PERMIT PATCHING. WHERE EXISTING CIRCUITRY IS BEING UTILIZED FOR CONNECTION OF NEW
- LOAD OR BEING RETAINED FOR EXISTING LOADS AND SUCH CIRCUITRY IS NOT EXACTLY AS INDICATED ON PLANS, MAKE SUCH MODIFICATIONS AS MAY BE REQUIRED TO WIRING TO ACCOMPLISH THE DESIGN INTENT. WHERE EXISTING LIGHTING, EQUIPMENT, WIRING, ETC. IS INDICATED AS REMAINING AND SUCH ITEMS INTERFERE WITH THE INSTALLATION OR THE
- DEMOLITION WORK OF OTHER TRADES, DISCONNECT, REMOVE, AND RELOCATE TO AVOID CONFLICTS. REINSTALL AND RECONNECT SUCH ITEMS AS REQUIRED. WHERE EXISTING FIXTURES ARE BEING REMOVED AND SUCH REMOVAL
- DISTURBS THE CIRCUITRY TO FIXTURES WHICH ARE TO REMAIN, PROVIDE ALL NECESSARY MODIFICATIONS AND ADDITIONS TO WIRING AS REQUIRED TO RETAIN SERVICE AND SWITCH CONTROL FOR REMAINING FIXTURES. NUMBERS INDICATED FOR BRANCH CIRCUITS ARE FOR GROUPING ONLY. ALL PANELBOARD DIRECTORIES ARE TO BE UPDATED FOR FUTURE

POWER PLAN NOTES:

- WHERE EXISTING WIRING AND CIRCUITRY WHICH IS TO REMAIN IS LEFT EXPOSED BY DEMOLITION AND REMOVAL OF PARTITION AND/OR HUNG
- CEILINGS, REPOUTE SUCH WIRING TO MAINTAIN THE CIRCUIT CONTINUITY. WHERE EXISTING WIRING AND CIRCUITRY TO REMAIN IS LEFT STUBBED UP FROM FLOOR BY THE DEMOLITION AND REMOVAL OF PARTITIONS, REPOUTE
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- NUMBERS INDICATED FOR BRANCH CIRCUITS ARE FOR GROUPING ONLY. ALL PANELBOARD DIRECTORIES ARE TO BE UPDATED FOR FUTURE

CONTRACTOR SHALL COORDINATE ALL DATA LOCATIONS, DEVICES, WIRING,

EQUIPMENT, ETC. WITH COLLEGE PRIOR TO INSTALLATION FOR CONNECTION

KEY NOTES:

TO CAMPUS SYSTEM.

- CONTRACTOR TO PROVIDE AND INSTALL NEW CUSTOMER SUB-METERING TO INCOMING ELECTRICAL POWER TO THE PANELBOARD. SUB-METERING TO BE SIMILAR TO MFR: E-MON D-MON; MODEL: E50-208200-ROIKIT-05, OR OWNER/ENGINEER APPROVED EQUAL.
- (2) CONTRACTOR TO PROVIDE AND INSTALL TWO (2) NEW MOLDED-CASE, 120/240 VAC, 20A, I-POLE, IO KAIC, CIRCUIT BREAKERS IN EXISTING PANELBOARD "PPHR", SPACES #15 AND #16.
- CONTRACTOR TO PROVIDE AND INSTALL THREE (3) NEW MOLDED-CASE, 120/240 VAC, 20A, I-POLE, IO KAIC, CIRCUIT BREAKERS IN EXISTING
- CONTRACTOR TO PROVIDE AND INSTALL TWO (2) NEW MOLDED-CASE, 120/240 VAC, 20A, 1-POLE, 10 KAIC, CIRCUIT BREAKERS IN EXISTING

_____/₄


NEW MINI-DOME SECURITY CAMERA FURNISHED AND INSTALLED BY OTHER

Revisions

Description

03-06-15 ISSUED FOR DCA FILING 03-18-15 ISSUED FOR BIDDING ISSUED FOR DCA FILING & CONSTRUCTION 03-27-15 ISSUED FOR ADDENDUM #1 04-07-15

Key Plan

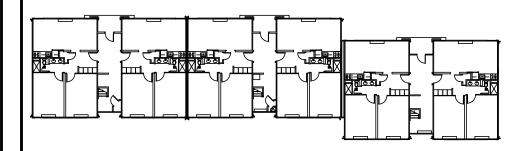

Consultants

LINWOOD ENGINEERING ASSOCIATES, P.A.



INTERIOR RENOVATIONS AT THE MIMOSA - G RESIDENCE



DCA PROJECT# 9071-15

RAMAPO OF NEW JERSEY

505 Ramapo Valley Road Mahwah, New Jersey 07430-1680

Architects & Engineers, PC 1 PARAGON DRIVE . MONTVALE . NEW JERSEY . 07645 tel: 201.573.1767 fax: 201.573.0808 www.sns—arch—eng.com

Fay W. Logan, AIA John M. Lignos, AIA Lorin J. Sonenshine, AIA

Steven Napolitano, PE O

Scale

AS NOTED Checked By 56 CRAWL SPACE, FIRST FLOOR \$


SECOND FLOOR ELECTRICAL PLANS

Michael T. Davina, P.E. Robert J. Hatch, P.E. NJ #48654 CT #0025779

MA #48516 NJ #30419

NY #56608 PA #036014-E

Work Order No.

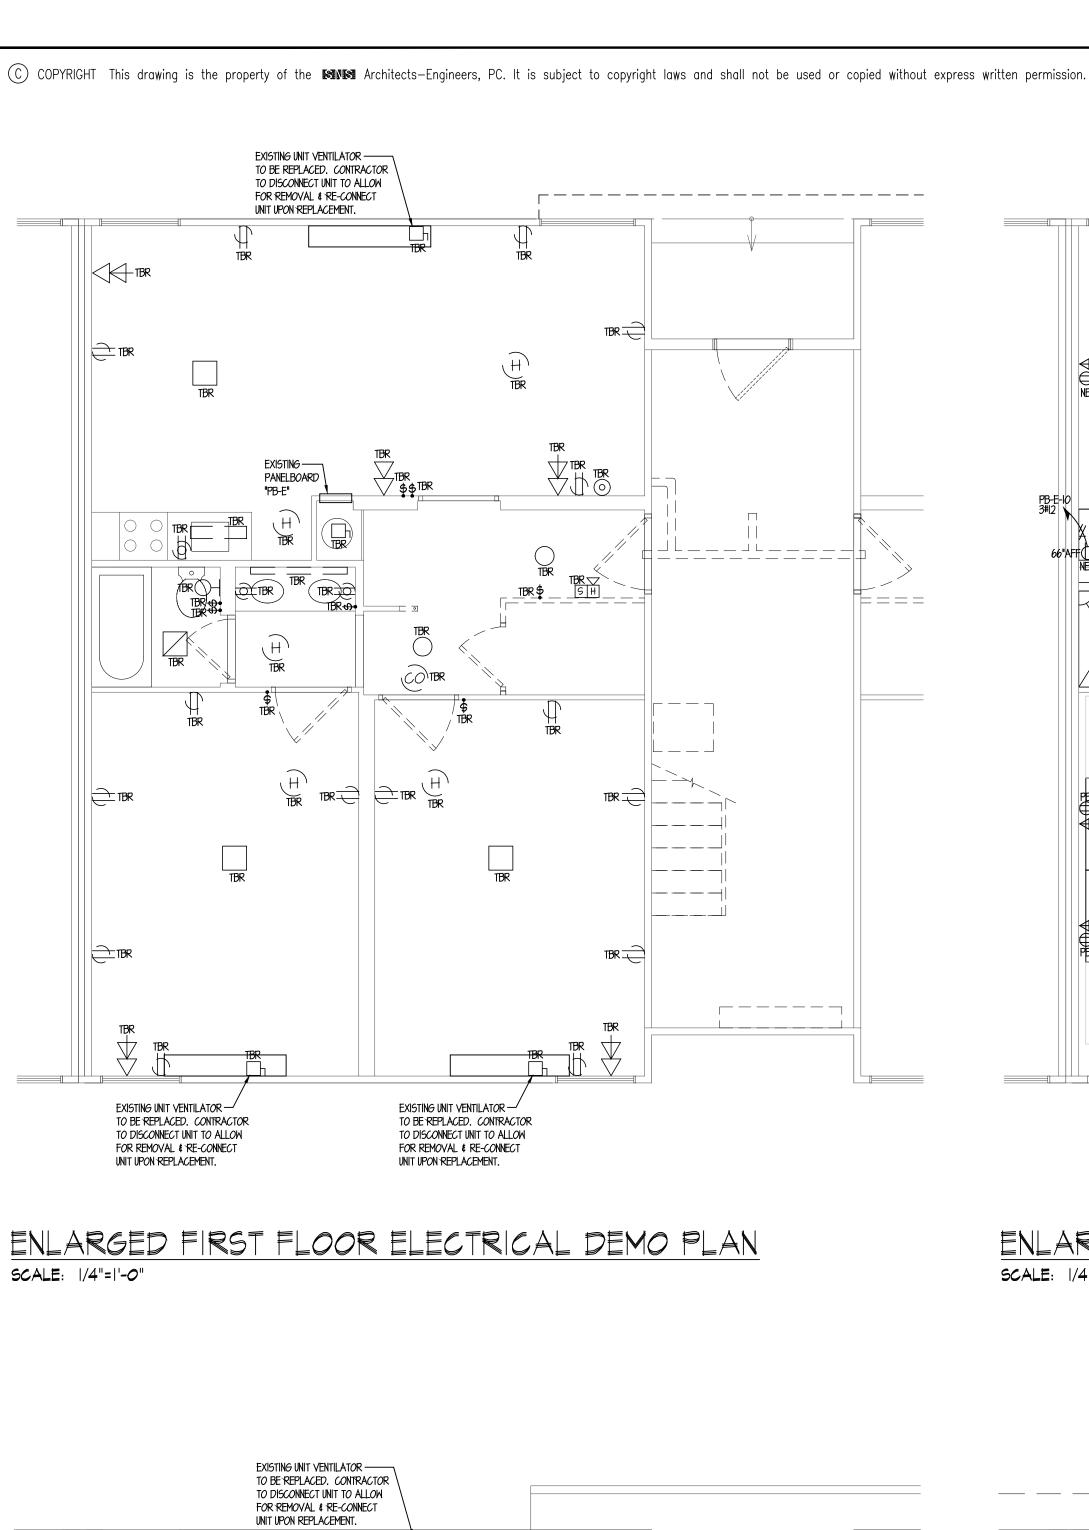

NEW UNIT VENTILATOR. CONTRACTOR TO RE-CONNECT UNIT UPON REPLACEMENT. PANELBOARD VESTIBULE 101EF 105E NEW UNIT VENTILATOR. — NEW UNIT VENTILATOR. — CONTRACTOR TO RE-CONNECT CONTRACTOR TO RE-CONNECT UNIT UPON REPLACEMENT. UNIT UPON REPLACEMENT.

ENLARGED FIRST FLOOR POWER PLAN

CONTRACTOR TO RE-CONNECT

UNIT UPON REPLACEMENT.

PANELBOARD \

-CONTRACTOR TO RE-CONNECT

UNIT UPON REPLACEMENT.

BRIDGE 201GH

NEW 🔷 .

SCALE: 1/4"=1'-0"

◆NEW →PB-G-8

PB-6-2 NEW → NEW

◆NEW NEW PB-G-2

NEW UNIT VENTILATOR. —

UNIT UPON REPLACEMENT.

-- CONTRACTOR TO RE-CONNECT

- xaxd- - - - - - - - - - - - | ------— — — — NÉW — — — — — — — — — —

ENLARGED FIRST FLOOR LIGHTING PLAN SCALE: 1/4"=1'-0"


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UNIT UPON REPLACEMENT.

UNIT UPON REPLACEMENT.

SCALE: 1/4"=1'-0"

ENLARGED SECOND FLOOR ELECTRICAL DEMO PLAN ENLARGED SECOND FLOOR POWER PLAN SCALE: 1/4"=1'-0"

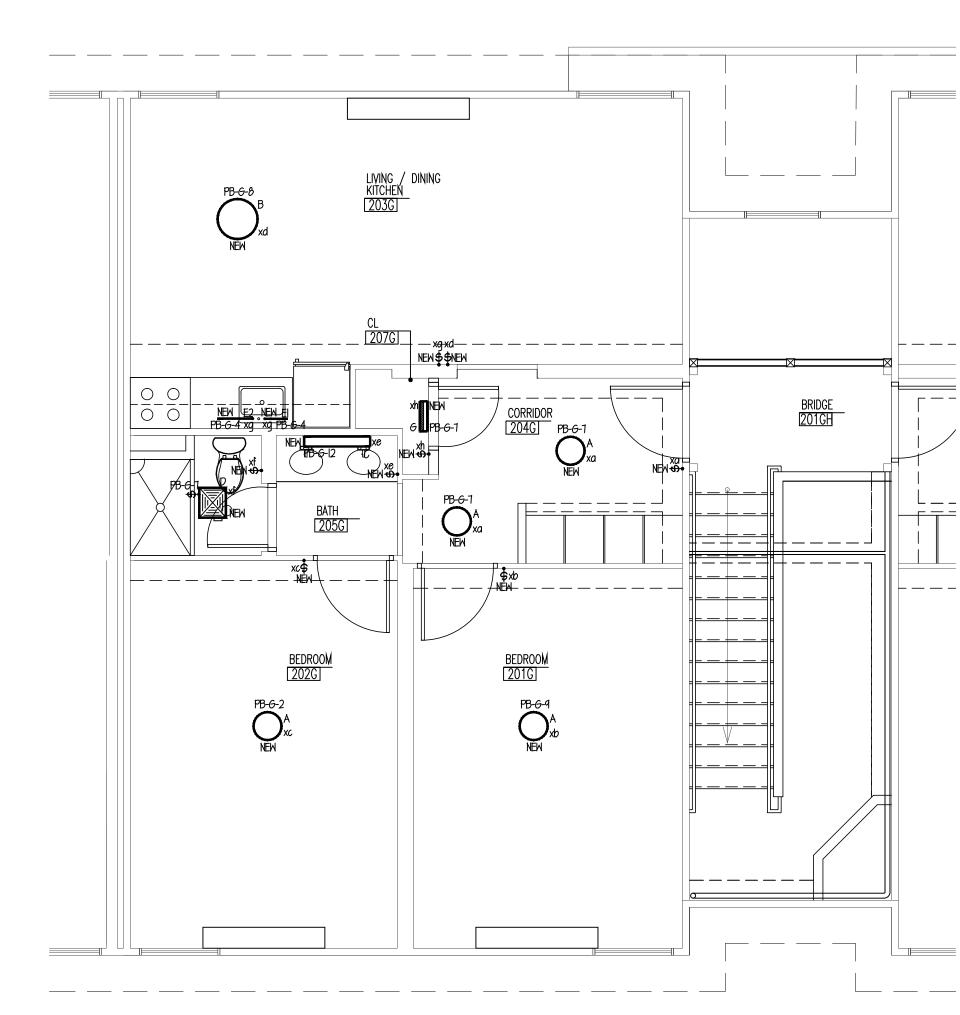

ENLARGED SECOND FLOOR LIGHTING PLAN SCALE: 1/4"=1'-0"

Michael T. Davina, P.E. Robert J. Hatch, P.E. NJ #48654 CT #0025779 CA #E16118 CT #13318 FL #69560 MA #48516 NJ #30419 NV #019975 NY #56608 PA #036014-E

ELECTRICAL DEMOLITION NOTES:

- I. DO NOT CONSIDER DEMOLITION AND ALTERATION NOTES TO BE ALL INCLUSIVE. IT IS THE CONTRACTOR'S RESPONSIBILITY TO INSPECT AND ASSESS EACH SPACE, AND TO FULFILL THE INTENT OF THE WORK INDICATED BY THE CONTRACT DOCUMENTS. VERIFY ALL DIMENSIONS WITHIN THE CONTRACT
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EQUIPMENT, CONTROL SYSTEMS AND ACCESSORIES. ELECTRICAL

- PROVIDE A MINIMUM OF 30 FOOTCANDLES THROUGHOUT AREA 4. DO ALL NECESSARY DEMOLITION AND REMOVAL OF EXISTING
- LIGHTING, EXISTING FIRE ALARM SYSTEM AND ELECTRICAL EQUIPMENT AS REQUIRED. 5. DEMOLITION TO BE PERFORMED AFTER NORMAL WORKING
- HOURS IF REQUIRED BY THE OWNER. REPOUTE AND RECONNECT ALL CIRCUITING TO EXISTING LOADS
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TO PERMIT PATCHING.

CONDUITS NOT BEING RETAINED OR REUSED. REMOVE ALL DEVICES AND ASSOCIATED WIRING AND CONDUITS FROM EXISTING OUTLETS, SWITCHES, FIRE ALARM DEVICES, ETC. BEING REMOVED TO PERMIT PATCHING OVER THE ARCHITECTURAL SURFACE.

8. DISCONNECT AND REMOVE ALL EXISTING WIRING AND EXPOSED

IO. WHERE EXISTING WIRING AND CIRCUITRY WHICH IS TO REMAIN IS LEFT EXPOSED BY DEMOLITION AND REMOVAL OF PARTITION AND/OR HUNG CEILINGS, REPOUTE SUCH WIRING TO MAINTAIN THE CIRCUIT CONTINUITY.

WHERE EXISTING LIGHTING, EQUIPMENT, WIRING, ETC. IS

- INDICATED AS REMAINING AND SUCH ITEMS INTERFERE WITH THE INSTALLATION OR THE DEMOLITION WORK OF OTHER TRADES, DISCONNECT, REMOVE, AND RELOCATE TO AVOID CONFLICTS. REINSTALL AND RECONNECT SUCH ITEMS AS REQUIRED. WHERE EXISTING LIGHTING FIXTURES AND DEVICES ARE BEING REMOVED AND SUCH REMOVAL DISTURBS THE CIRCUITRY TO LIGHTING FIXTURES AND DEVICES WHICH ARE TO REMAIN.
- PROVIDE ALL NECESSARY MODIFICATIONS AND ADDITIONS TO WIRING AS REQUIRED TO RETAIN SERVICE AND SWITCH 13. RELOCATE EXISTING ACTIVE OUTLET BOXES, JUNCTION BOXES, ETC., WHICH ARE RENDERED INACCESSIBLE BY NEW
- CONSTRUCTION. 14. ALL EXISTING BRANCH CIRCUIT WIRING FROM RESIDENTIAL TENANT PANELS SHALL BE REMOVED.

ALL DEMOLITION WORK IS BY OTHERS UNDER SEPARATE CONTRACT AND FILED UNDER SEPARATE DCA PERMIT.

LIGHTING NOTES:

- WHERE EXISTING WIRING AND CIRCUITRY WHICH IS TO REMAIN IS LEFT EXPOSED BY DEMOLITION AND REMOVAL OF PARTITION AND/OR HUNG
- CEILINGS, REPOUTE SUCH WIRING TO MAINTAIN THE CIRCUIT CONTINUITY. WHERE EXISTING WIRING AND CIRCUITRY TO REMAIN IS LEFT STUBBED UP FROM FLOOR BY THE DEMOLITION AND REMOVAL OF PARTITIONS, REPOUTE SUCH WIRING AS REQUIRED TO MAINTAIN CIRCUIT CONTINUITY AND CUT
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 WHERE EXISTING CIRCUITRY IS BEING UTILIZED FOR CONNECTION OF NEW LOAD OR BEING RETAINED FOR EXISTING LOADS AND SUCH CIRCUITRY IS
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- 5. WHERE EXISTING FIXTURES ARE BEING REMOVED AND SUCH REMOVAL DISTURBS THE CIRCUITRY TO FIXTURES WHICH ARE TO REMAIN, PROVIDE ALL NECESSARY MODIFICATIONS AND ADDITIONS TO WIRING AS REQUIRED TO RETAIN SERVICE AND SWITCH CONTROL FOR REMAINING FIXTURES. NUMBERS INDICATED FOR BRANCH CIRCUITS ARE FOR GROUPING ONLY.

ALL PANELBOARD DIRECTORIES ARE TO BE UPDATED FOR FUTURE

POWER PLAN NOTES:

- WHERE EXISTING WIRING AND CIRCUITRY WHICH IS TO REMAIN IS LEFT EXPOSED BY DEMOLITION AND REMOVAL OF PARTITION AND/OR HUNG CEILINGS, REPOUTE SUCH WIRING TO MAINTAIN THE CIRCUIT CONTINUITY. WHERE EXISTING WIRING AND CIRCUITRY TO REMAIN IS LEFT STUBBED UP FROM FLOOR BY THE DEMOLITION AND REMOVAL OF PARTITIONS, REPOUTE SUCH WIRING AS REQUIRED TO MAINTAIN CIRCUIT CONTINUITY AND CUT BACK CONDUIT BELOW TOP OF FINISHED SLAB TO PERMIT PATCHING. WHERE EXISTING CIRCUITRY IS BEING UTILIZED FOR CONNECTION OF NEW
- LOAD OR BEING RETAINED FOR EXISTING LOADS AND SUCH CIRCUITRY IS NOT EXACTLY AS INDICATED ON PLANS, MAKE SUCH MODIFICATIONS AS MAY BE REQUIRED TO WIRING TO ACCOMPLISH THE DESIGN INTENT. 4. WHERE EXISTING LIGHTING, EQUIPMENT, WIRING, ETC. IS INDICATED AS REMAINING AND SUCH ITEMS INTERFERE WITH THE INSTALLATION OR THE DEMOLITION WORK OF OTHER TRADES, DISCONNECT, REMOVE, AND
- RELOCATE TO AVOID CONFLICTS. REINSTALL AND RECONNECT SUCH ITEMS AS REQUIRED. WHERE EXISTING FIXTURES ARE BEING REMOVED AND SUCH REMOVAL DISTURBS THE CIRCUITRY TO FIXTURES WHICH ARE TO REMAIN, PROVIDE ALL NECESSARY MODIFICATIONS AND ADDITIONS TO WIRING AS REQUIRED TO RETAIN SERVICE AND SWITCH CONTROL FOR REMAINING FIXTURES.
 - CONTRACTOR SHALL COORDINATE ALL DATA LOCATIONS, DEVICES, WIRING, EQUIPMENT, ETC. WITH COLLEGE PRIOR TO INSTALLATION FOR CONNECTION

NUMBERS INDICATED FOR BRANCH CIRCUITS ARE FOR GROUPING ONLY.

ALL PANELBOARD DIRECTORIES ARE TO BE UPDATED FOR FUTURE


Revisions

04-07-15

Description 03-06-15 ISSUED FOR DCA FILING 03-18-15 ISSUED FOR BIDDING 03-27-15 ISSUED FOR DCA FILING & CONSTRUCTION

ISSUED FOR ADDENDUM #1

Key Plan

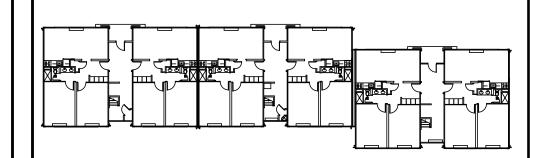

Consultants

LINWOOD ENGINEERING ASSOCIATES, P.A.

CONSULTING MECHANICAL & ELECTRICAL ENGINEERS




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INTERIOR RENOVATIONS MIMOSA - G RESIDENCE



DCA PROJECT# 9071-15



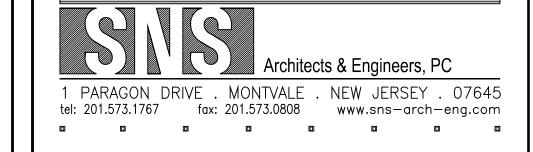

Fay W. Logan, AIA John M. Lignos, AIA Lorin J. Sonenshine, AIA O

Steven Napolitano, PE

Cert./Lic. No. Scale 02-03-I5 AS NOTED Checked By Drawn By Dwg. Title

ENLARGED FIRST & SECOND FLOOR

ELECTRICAL PLANS Work Order No.

Dwg. No.

MECHANICAL NOTES AND SPECIFICATIONS

- A. CONTRACTOR SHALL PERFORM ALL WORK AS TO CONFORM TO LOCAL, STATE AND NATIONAL CODES AND THE REQUIREMENTS OF LOCAL AUTHORITIES HAVING
- B. CONTRACTOR TO EXAMINE THE SITE TO DETERMINE THE EXACT CONDITIONS EFFECTING THE MECHANICAL WORK, THE CONTRACTOR SHALL VERIFY ALL DIMENSIONS NOTED ON THE PLANS.
- DRAWINGS INDICATE THE GENERAL SCHEME OF THE INSTALLATION AND ARE DIAGRAMMATIC IN SCOPE. THE ENGINEER RESERVES THE RIGHT TO CHANGE THE LOCATION OF DUCTWORK, PIPING, DIFFUSERS, APPARATUS, ETC. TO A REASONABLE EXTENT AS THE BUILDING CONDITIONS MAY DICTATE PRIOR TO THEIR INSTALLATION WITHOUT EXTRA COST TO THE OWNER. THE EXACT LOCATION AND ARRANGEMENT OF ALL EQUIPMENT AND PARTS SHALL BE DETERMINED AS THE WORK PROGRESSES.
- D. DETAILS OF CONSTRUCTION AND OF WORKMANSHIP WHERE NOT SPECIFICALLY DESCRIBED HEREIN OR INDICATED ON THE DRAWINGS SHALL BE SUBJECT TO THE ENGINEER'S APPROVAL, IT IS THE INTENT OF THESE SPECIFICATIONS TO PROVIDE COMPLETE SYSTEMS, CONSTRUCTED WITH NEW AND FIRST QUALITY MATERIALS AND EQUIPMENT, LEFT IN GOOD WORKING ORDER, READY FOR
- SCRAP, DEBRIS AND ABANDONED HVAC EQUIPMENT/DUCTWORK/SUPPORTS/CONTROLS AND ACCESSORIES SHALL, EXCEPT AS OTHERWISE SPECIFIED, BE REMOVED FROM THE SITE AND DISPOSED OF BY THIS CONTRACTOR.
- F. THE CONTRACTOR SHALL BE RESPONSIBLE FOR START-UP OF ALL SYSTEMS.
- G. ALL WORK SHALL BE DONE WITH A MINIMUM OF DUST AND DIRT. PROVIDE SUFFICIENT FIREPROOF TARPAULINS AND COVER ALL EQUIPMENT IN WORK AREA WITH SAME DURING WORK OPERATIONS.
- H. CONTRACTOR SHALL FURNISH SHOP DRAWINGS AND EQUIPMENT CUTS TO THE ARCHITECT FOR APPROVAL (MINIMUM (5) COPIES). THE ENGINEER'S APPROVAL SHALL NOT RELIEVE THE CONTRACTOR FROM HIS OBLIGATION TO COMPLY WITH THE INFORMATION CONTAINED IN THE CONTRACT DOCUMENTS.
- I. CONTRACTOR SHALL COORDINATE CONNECTIONS TO STREET WITH LOCAL UTILITY

K. ALL WORK SHALL BE IN STRICT CONFORMANCE WITH THE STATE OF NEW JERSEY

UNIFORM CONSTRUCTION CODE, THE STATE OF NEW JERSEY UNIFORM FIRE CODE

- CONTRACTOR SHALL FILE, SECURE AND PAY FOR ANY NECESSARY APPROVALS, PERMITS AND INSPECTIONS.
- (NJAC #5-18), THE STATE OF NEW JERSEY FIRE PREVENTION CODE, THE INTER-NATIONAL BUILDING CODE, THE INTERNATIONAL MECHANICAL CODE AND THE ASHRAE 90.1-2007, ENERGY CONSERVATION CODE.
- PRIOR TO TESTING, CONTRACTOR SHALL MAKE ALL SYSTEM ADJUSTMENTS REQUIRED FOR PROPER OPERATION. ADJUSTMENTS SHALL INCLUDE AIR BALANCING, HYDRONIC BALANCING, ETC.
- M. ALL SYSTEMS SHALL BE TESTED IN ACCORDANCE WITH THE INTERNATIONAL MECHANICAL CODE AND THE STATE OF NEW JERSEY FIRE PREVENTION CODE.
- CONTRACTOR TO COORDINATE TESTS WITH LOCAL OFFICIALS. N. CONTRACTOR SHALL BE RESPONSIBLE FOR DISCONNECTING ALL FACILITIES IN

AREAS INDICATED FOR DEMOLITION ON THE ARCHITECTURAL DRAWINGS.

- WHERE DEMOLITION OF EXISTING SERVICES RESULTS IN THE INTERRUPTION OF DUCTWORK, MECHANICAL PIPING, ETC. SERVING AREAS WHICH ARE TO REMAIN, INSTALL BYPASS CONNECTIONS AS REQUIRED TO RESTORE REMAINING SERVICES TO OPERATION. SIZING, MATERIAL, JOINTINGS AND INSULATION OF BYPASS CONNECTIONS SHALL MATCH EXISTING INSTALLATION.
- P. ALL WORK SHALL BE GUARANTEED TO BE FREE FROM DEFECT FOR ONE YEAR AFTER ACCEPTANCE OF WORK.
- Q. THE CONTRACTOR'S PROPOSAL AND BASE BID MUST COVER ALL ITEMS IN THE PLANS AND SPECIFICATIONS/NOTES EXACTLY AS DRAWN, NOTED, SCHEDULED, DETAILED AND SPECIFIED. TO RECEIVE CONSIDERATION FOR A SUBSTITUTION OF MATERIALS AND/OR EQUIPMENT, THE CONTRACTOR MUST INCLUDE THE FOLLOWING INFORMATION WITH HIS BASE BID:
- DOCUMENTATION OF EQUALITY. A SIDE-BY-SIDE COMPARISON, OF PERFORMANCE AND CONSTRUCTION MATERIALS, BETWEEN THE SPECIFIED ITEM AND THE PROPOSED SUBSTITUTION. THE DOLLAR VALUE FOR CREDIT, ASSOCIATED WITH THE SUBSTITUTED ITEM(S), SHALL BE ITEMIZED IN THE BASE BID
- R. IN ACCORDANCE WITH IMC 2009, SECTION 602.1, THE FOLLOWING REQUIREMENTS SHALL APPLY TO ALL WIRING LOCATED IN A PLENUM CEILING:
- a. MUST BE LOW VOLTAGE OR POWER LIMITED. b. FLAME SPREAD NOT GREATER THAN FIVE FEET. c. WIRE SHALL BEAR THE LABEL OF AN APPROVED AGENCY AND BE MARKED
- IN ACCORDANCE WITH NFPA TO. d. THERMAL AND ACOUSTICAL MATERIALS AND PIPE INSULATION MUST HAVE A FLAME SPREAD RATING OF 25 OR LESS AND A SMOKE DEVELOPED RATING RATING OF 50 OR LESS WHEN TESTED IN ACCORDANCE WITH ASTM E84.

2. SCOPE OF WORK

- A. THE WORK SHALL INCLUDE BUT NOT BE LIMITED TO THE FOLLOWING:
- B. FURNISH AND INSTALL ALL NEW EXHAUST AIR DUCTWORK.
- C. FURNISH AND INSTALL INSULATION FOR ALL SUPPLY & RETURN AIR DUCTWORK.
- D. FURNISH AND INSTALL ALL FAN COIL UNITS AS SHOWN ON DRAWINGS AND SPECIFIED IN SCHEDULES.
- E. FURNISH AND INSTALL ALL CEILING MOUNTED CABINET EXHAUST FANS AS SHOWN ON DRAWINGS AND SPECIFIED IN SCHEDULES.
- F. FURNISH AND INSTALL ALL HANGERS AND SUPPORTS.
- G. FURNISH AND INSTALL ALL HOT/CHILLED WATER PIPES FOR FAN COIL UNITS AS REQUIRED.
- H. SHOP DRAWINGS.

ACCEPTANCE.

- ENGAGE THE SERVICES OF AN APPROVED INDEPENDENT AIR BALANCING COMPANY TO BALANCE THE SYSTEMS, AND ISSUE AN AIR BALANCING REPORT. THE INDEPENDENT AIR BALANCING COMPANY SHALL BE SUBJECT TO THE ENGINEER'S APPROVAL. IF NECESSARY, PROVIDE MANUAL VOLUME DAMPERS AT BRANCH DUCTWORK TO ASSURE PROPER AIR BALANCE.
- J. ALTERATIONS, REMOVALS, AND DISPOSAL.
- K. CUTTING AND ROUGH PATCHING.
- OBTAINING AND PAYING FOR ALL NECESSARY PERMITS, INSPECTIONS AND CERTIFICATES REQUIRED IN CONNECTION WITH THIS WORK.
- M. REMOVE ALL WORK INDICATED ON THE DRAWINGS.
- N. REMOVE ALL EXISTING HVAC EQUIPMENT AS SHOWN ON PLANS.
- O. FURNISH AND INSTALL INSULATION FOR ALL HOT/CHILLED WATER PIPING. P. GUARANTEE ALL WORK FOR A PERIOD OF ONE YEAR FROM THE FINAL DATE OF

3. WORK NOT INCLUDED

THE FOLLOWING ITEMS OF WORK SHALL BE PROVIDED UNDER OTHER CONTRACTS: A. FINISHED PATCHING AND PAINTING.

4. NOISE CONTROL

A. ALL INSTALLATION SHALL BE IN A MANNER THAT THE NOISE CRITERIA LEVEL IN THE SPACE SHALL NOT EXCEED NC=35. NOISE LEVELS ABOVE THIS LIMIT WILL NOT BE ACCEPTABLE AND SHOULD BE CORRECTED BY THIS CONTRACTOR AT

DUCTWORK DIMENSIONS NOTED ON THE PLANS ARE CLEAR INSIDE DIMENSIONS.

NO EXPENSE TO THE OWNER. B. ALL SUPPLY AND RETURN DUCTWORK SHALL BE PROVIDED WITH I" INTERNAL ACOUSTIC LINING AT LEAST 20' FROM EACH AIR HANDLING UNIT. ALL

5. VIBRATION CONTROL

BUILDING STRUCTURE.

- A. ALL INSTALLATIONS SHALL BE IN SUCH A MANNER THAT VIBRATION FROM ROTATING EQUIPMENT IS ISOLATED FROM DUCTWORK, PIPING AND THE
- B. FLEXIBLE CONNECTIONS SHALL BE PROVIDED AT ALL LOCATIONS WHERE RIGID DUCTWORK CONNECTS TO FANS, AIR HANDLERS, OR OTHER EQUIPMENT CAPABLE OF PRODUCING OBJECTIONABLE VIBRATION. FLEXIBLE CONNECTIONS SHALL BE 30 OZ. NEOPRENE COATED FABRIC SECURED WITH HEAVY DUTY BANDS OR
- C. FLEXIBLE CONNECTIONS SHALL BE PROVIDED AT ALL LOCATIONS WHERE PIPING CONNECTS TO PUMPS OR OTHER EQUIPMENT CAPABLE OF PRODUCING OBJECTIONABLE VIBRATION.
- D. ALL EQUIPMENT SUPPORTED FROM THE BUILDING STRUCTURE SHALL BE PROVIDED WITH SPRING-TYPE VIBRATION ISOLATORS.

6. SHEET METAL DUCTWORK

- A. ALL RECTANGULAR DUCTWORK, UNLESS OTHERWISE NOTED. SHALL BE BUILT FROM GALVANIZED SHEET STEEL AND THOROUGHLY BRACED & STIFFENED, ALL DUCTWORK DIMENSIONS NOTED ON THE PLANS ARE CLEAR INSIDE DIMENSIONS.
- B. FABRICATION OF SHEET METAL DUCTS SHALL BE IN ACCORDANCE WITH RECOMMENDATIONS OF ASHRAE, LATEST EDITION, OR AS PER SMACNA DUCT CONSTRUCTION MANUAL(S). ALL BRANCH DUCTWORK AND TAKE-OFFS SHALL BE PROVIDED WITH VOLUME DAMPERS.
- C. CONTRACTOR SHALL SEAL ALL DUCTWORK JOINTS WITH 3M EC-800 OR APPROVED
- D. UNLESS OTHERWISE NOTED, ALL DUCTWORK SHALL BE CONCEALED WITHIN CEILINGS, WALLS, FLOORS AND SHAFTS.
- E. ALL DUCTWORK GAUGES, AND INSTALLATION SHALL CONFORM TO THE LATEST EDITION OF SMACNA STANDARDS.
- F. CHANGES IN SHAPE AND DIMENSION SHALL CONFORM TO THE FOLLOWING: EXCEPT WHERE OTHERWISE NOTED, FOR INCREASES IN CROSS-SECTIONAL AREA, THE SHAPE OF THE TRANSFORMATION SHALL NOT EXCEED I" IN 7", SPACE CONDITIONS PERMITTING. EXCEPT WHERE OTHERWISE NOTED, FOR REDUCTIONS IN AREA, THE SLOPE SHALL NOT BE LESS THAN I" IN 7", SPACE CONDITIONS
- G. THE CONSTRUCTION FOR LOW PRESSURE RECTANGULAR SHEET METAL DUCTS SHALL BE MADE IN ACCORDANCE WITH RECOMMENDATIONS OF ASHRAE GUIDE, LATEST EDITION, OR AS PER SMACNA MANUAL BUT NOT LESS THAN THE FOLLOWING WEIGHTS AND CONSTRUCTION:

DIMENSION OF LONGEST SIDE	SHEET M	M GAUGE OF ETAL FOR ALL DES OF DUCT	TRANSVERSE REINFORCING AT
OF DUCT (INCHES)	STEEL (GAUGE)	ALUMINUM THICKNESS (INCHES)	AND BETWEEN DUCT JOINTS
UP THRU 12	26	0.020	I" POCKET LOCK 24 GAUGE, STANDING SEAM JOINT 24 GAUGE, I" STANDING S SLIP 24 GAUGE. JOINT MAX. ON 8 FT. CENTERS.

- H. FLAT AREAS OF DUCT OVER 18 IN. WIDE SHALL BE STIFFENED BY CROSS
- BREAKING OF BEADING.
- I. ALL JOINTS SHALL HAVE CORNER CLOSURES.
- J. PROVIDE 3M CO.'S GASKET EC-1202 GASKET AT FLANGED JOINTS AND ALL SLIP JOINTS SHALL BE SEALED WITH 3M CO,'S EC-800. JOINTS SHALL BE MAXIMUM ON & FEET CENTERS.
- K. THIS CONTRACTOR MAY ELECT THE OPTION OF USING STANDARD PREFABRICATED SPIRAL CONSTRUCTION CONDUIT AND PREFABRICATED FITTINGS AS MADE BY UNITED SPIRAL CO. OR APPROVED EQUAL. ALL
- JOINTS SHALL BE SEALED WITH 3M CO.'S EC-800. L. ALL JOINTS IN A DUCT SYSTEM MUST BE TIGHT IN ORDER TO ENSURE PROPER AIR DISTRIBUTION AND STRUCTURAL INTEGRITY. DUCT SUPPORT SHALL NOT EXCEED IO FEET.

7. FLEXIBLE DUCTWORK

- A. FLEXIBLE DUCTWORK SHALL BE PERMITTED FOR USE BETWEEN BRANCH DUCTWORK AND CEILING DIFFUSERS IN LENGTHS NOT EXCEEDING 6'-O".
- B. LOW PRESSURE FLEXIBLE DUCTWORK SHALL BE A FACTORY ASSEMBLY OF LOW FRICTION, POLYMER INNER LINER APPLIED OVER A MECHANICALLY INTERLOCKED, GALVANIZED STEEL HELIX. INSULATION SHALL BE FIBERGLASS WITH A THERMAL CONDUCTANCE OF NOT MORE THAN 0.23. THE OVERALL ASSEMBLY SHALL BE JACKETED WITH A POLYETHYLENE VAPOR BARRIER HAVING A PERMEANCE OF NOT GREATER THAN O.I WHEN TESTED IN ACCORDANCE WITH ASTM #E96, PROCEDURE A. ASSEMBLY SHALL BE RATED FOR A MAXIMUM WORKING PRESSURE OF 6" W.C. POSITIVE 4" W.C. NEGATIVE, 4,000 FPM MAXIMUM VELOCITY AND -20°F TO 250°F OPERATING TEMPERATURE. MINIMUM BURST PRESSURE SHALL BE NOT LESS THAN 250% OF RATED WORKING PRESSURE. DUCT SHALL BE U.L. LISTED AS "CLASS O" OR "CLASS I" FLEXIBLE AIR DUCT UNDER U.L. #181 AND SHALL BE SO IDENTIFIED FLAME SPREAD RATING SHALL BE LESS THAN 25. U.L. SMOKE DEVELOPED RATING SHALL BE LESS THAN 50. LOW PRESSURE FLEXIBLE DUCT SHALL BE "TYPE 9-INSULATED"
- AS MANUFACTURED BY FLEXMASTER U.S.A., INC., OR ENGINEER APPROVED EQUAL. C. ALL FLEXIBLE DUCTWORK SHALL BE SECURED USING HEAVY DUTY, STAINLESS STEEL

- A. ALL PIPE SHALL BE NEW, FREE FROM SCALE OR RUST, OF THE MATERIAL AND WEIGHT SPECIFIED UNDER THE VARIOUS SERVICES. EACH LENGTH OF PIPE SHALL BE PROPERLY MARKED AT THE MILL FOR PROPER IDENTIFICATION WITH NAME OR SYMBOL OF MANUFACTURER.
- B. ALL FITTINGS USED AT EXPANSION LOOPS OR BENDS SHALL BE EXTRA HEAVY.

C. ALL HOT/CHILLED WATER PIPING SHALL BE SCHEDULE 40 STEEL.

- D. PROVIDE NECESSARY STRUCTURAL MEMBERS, HANGERS AND SUPPORTS OF APPROVED DESIGN TO KEEP PIPING IN PROPER ALIGNMENT AND PREVENT TRANSMISSION OF INJURIOUS THRUSTS AND VIBRATIONS. IN ALL CASES WHERE HANGERS, BRACKETS, ETC., ARE SUPPORTED FROM METAL DECKING AND/OR CONCRETE CONSTRUCTION, CARE SHALL BE TAKEN NOT TO WEAKEN DECKING AND/OR CONCRETE OR PENETRATE WATERPROOFING. ALL HANGERS AND SUPPORTS SHALL BE CAPABLE OF SCREW ADJUSTMENT AFTER PIPING IS ERECTED. HANGERS SUPPORTING PIPING EXPANDING INTO LOOPS, BENDS AND OFFSETS SHALL BE SECURED TO THE BUILDING STRUCTURE IN SUCH A MANNER THAT HORIZONTAL ADJUSTMENT PERPENDICULAR TO THE RUN OF PIPING SUPPORTED MAY BE MADE TO ACCOMMODATE DISPLACEMENT DUE TO EXPANSION. ALL SUCH HANGERS SHALL BE FINALLY ADJUSTED, BOTH IN THE VERTICAL AND HORIZONTAL DIRECTION, WHEN THE SUPPORTED PIPING IS HOT OR CHILLED,
- E. ALL VERTICAL PIPING SHALL BE ANCHORED BY MEANS OF HEAVY STEEL CLAMPS SECURELY BOLTED OR WELDED TO THE PIPING AND WITH END EXTENSION BEARING ON THE BUILDING.
- F. ALL PIPING SHALL BE ERECTED SO AS TO ENSURE A PERFECT AND NOISELESS CIRCULATION THROUGHOUT THE SYSTEM.
- G. ALL VALVES AND SPECIALTIES SHALL BE SO PLACED AS TO PERMIT EASY OPERATION AND ACCESS.
- H. PROVIDE PROPER PROVISION FOR EXPANSION AND CONTRACTION IN ALL PORTIONS OF PIPEWORK, TO PREVENT UNDUE STRAINS ON PIPING OR APPARATUS CONNECTED THEREWITH. PROVIDE DOUBLE SWINGS AT RISER TRANSFERS AND OTHER OFFSETS WHEREVER POSSIBLE TO TAKE UP EXPANSION. ARRANGE RISER BRANCHES TO TAKE UP MOTION OF RISER.
- I. THE ENDS OF ALL PIPE AND NIPPLES SHALL BE THOROUGHLY REAMED TO THE FULL INSIDE DIAMETER OF THE PIPE AND ALL BURRS FORMED IN THE CUTTING OF THE PIPES SHALL BE REMOVED.
- J. PIPING SHALL BE INSTALLED IN ACCORDANCE WITH THE LATEST EDITION OF THE ASME CODE FOR PRESSURE PIPING.
- K. PIPING AT ALL EQUIPMENT AND CONTROL VALVES SHALL BE SUPPORTED TO PREVENT STRAINS OR DISTORTIONS IN THE CONNECTED EQUIPMENT AND CONTROL VALVES. PIPING SHALL BE SUPPORTED TO ALLOW FOR REMOVAL OF EQUIPMENT, VALVES AND ACCESSORIES WITH A MINIMUM OF DISMANTLING AND WITHOUT REQUIRING ADDITIONAL SUPPORTS AFTER THESE ITEMS ARE REMOVED.
- MISCELLANEOUS DRAINS, VENTS, RELIEFS, AND OVERFLOWS FROM TANKS, EQUIPMENT, PIPING, RELIEF VALVES, PUMPS, ETC., SHALL BE RUN TO THE NEAREST OPEN SIGHT DRAIN OR ROOF DRAIN. PROVIDE DRAIN VALVES WHENEVER REQUIRED FOR COMPLETE DRAINAGE OF PIPING, INCLUDING THE SYSTEM SIDE OF ALL PUMPS.
- M. INSTALL AIR VENTS IN CONDENSER, CHILLED AND HOT WATER PIPING AT ALL HIGH POINTS.

9. INSULATION

- A. PIPE INSULATION SHALL BE HEAVY DENSITY FIBERGLASS SECTIONAL PIPE INSULATION WITH A MAXIMUM K FACTOR OF 0.23 AT 75 DEGREES F MEAN TEMPERATURE WITH FACTORY APPLIED ALL SERVICE VAPOR BARRIER JACKET. DENSITY SHALL BE NOT LESS THAN 3 LBS. PER CUBIC FEET.
- B. INSULATE ALL HOT/CHILLED WATER PIPING WITH I-I/2" FIBERGLASS INSULATION WITH VAPOR BARRIER.

IO. SHOP DRAWINGS

- A. PRIOR TO ISSUING SHOP DRAWING SUBMITTALS FOR THE ENGINEER'S REVIEW. RACTOR SHALL BE RESPONSIBLE TO REVIEW ALL OF THE SUBMITTA DATA. THE CONTRACTOR SHALL STAMP EACH SHOP DRAWING CERTIFYING THAT THE CONTRACTOR'S REVIEW HAS BEEN COMPLETED AND THAT COORDINATION HAS BEEN ESTABLISHED.
- B. THE CONTRACTOR SHALL BE RESPONSIBLE TO COORDINATE HIS WORK WITH THE WORK OF ALL OTHER TRADES. ALL SHOP DRAWINGS SHALL ILLUSTRATE THAT COORDINATION HAS BEEN ESTABLISHED. FOR SHEETMETAL, PIPING AND EQUIPMENT LAYOUTS COMPOSITE DRAWINGS SHALL BE SUBMITTED. FIELD RELATED CONFLICTS SHALL BE RESOLVED BE THIS CONTRACTOR.
- SUBMIT SHOP DRAWINGS (PROVIDE A MINIMUM OF FIVE COPIES TO ARCHITECT FOR ENGINEERS APPROVAL) COVERING THE FOLLOWING ITEMS:
- DUCTWORK.
- PIPE HANGERS AND SUPPORTS.
- PIPE INSULATION. FAN COIL UNITS. FANS.
- CONTROLS. 8. AIR/HYDRONIC BALANCING REPORT.
- D. THE ENGINEER'S SHOP DRAWING APPROVAL SHALL NOT RELIEVE THE CONTRACTOR OF HIS RESPONSIBILITY TO COMPLY WITH ALL OF THE INFORMATION INDICATED IN THE CONTRACT DOCUMENTS (i.e. PLANS, SCHEDULES, DETAILS, NOTES AND SPECIFICATIONS ETC.).

II. TESTS AND BALANCING

- A. THE WORK OF THIS CONTRACTOR SHALL INCLUDE THE FURNISHING OF ALL TESTING INSTRUMENTS, GAUGES, AND OTHER EQUIPMENT REQUIRED FOR NECESSARY TESTS, REQUIRED BY LAW, RULES AND REGULATIONS AND AS
- B. NO VISIBLE LEAKS, LOSSES IN PRESSURE, OR INCREASE IN VACUUM SHALL OCCUR DURING TEST PERIOD.
- C. PROVIDE ALL OTHER TESTS REQUIRED BY BUILDING DEPARTMENT, FIRE DEPARTMENT AND ALL OTHER PUBLIC AGENCIES HAVING JURISDICTION.
- THE ARCHITECT AND SUCH OTHER PARTIES AS MAY HAVE LEGAL JURISDICTION. E. OPERATE THE INSTALLATION AFTER COMPLETION FOR PERIOD NECESSARY TO MAKE ALL REQUIRED ADJUSTMENTS FOR AUTOMATIC CONTROLS, AIR OUTLETS

AND FANS, UNTIL ALL PERFORMANCE CHARACTERISTICS ARE MET.

D. TESTS SHALL BE PERFORMED IN THE PRESENCE AND TO THE SATISFACTION OF

- ENGAGE THE SERVICES OF APPROVED INDEPENDENT AIR AND HYRDONIC BALANCING COMPANY TO BALANCE THE SYSTEM AND ISSUE AN AIR AND HYDRONIC BALANCING REPORT FOR ENGINEER'S APPROVAL. THE INDEPENDENT BALANCING COMPANY SHALL BE SUBJECT TO THE ENGINEER'S APPROVAL. THE TEST SHALL BE PERFORMED BY A PERSON HAVING A MINIMUM OF 5 YEARS EXPERIENCE IN TESTING AND BALANCING AIR AND HYDRONIC
- G. UPON COMPLETION OF THE INSTALLATION, THE AIR AND HYDRONIC BALANCE AND TESTING, SUBCONTRACTOR SHALL MAKE THE NECESSARY ADJUSTMENTS TO BALANCE THE SYSTEM.
- PROVIDE ANY EXTRA MANUAL VOLUME DAMPERS REQUIRED FOR PROPER AIR BALANCE. H. AT THE COMPLETION OF THE TEST, THE CONTRACTOR SHALL FURNISH THE ARCHITECT


SEVEN (1) COPIES OF THE FINAL TEST REPORT.

12. GUARANTEE


A. THE CONTRACTOR GUARANTEES BY HIS ACCEPTANCE OF THE CONTRACT THAT ALL WORK INSTALLED WILL BE FREE FROM ANY AND ALL DEFECTS FOR A PERIOD OF ONE YEAR FROM DATE OF COMPLETION AND ACCEPTANCE OF WORK.

HVAC SYMBOLS FOR ALTERATION WORK

RELOCATION	REMAIN	NEW	DESCRIPTION
\ - × - × - \	\	\	LOW PRESSURE DUCTWORK (SINGLE LINE
× ×			LOW PRESSURE DUCTWORK (DOUBLE LINE)
~ X ~~ X ~	~~~~	~~~	FLEXIBLE DUCT
			CEILING FAN

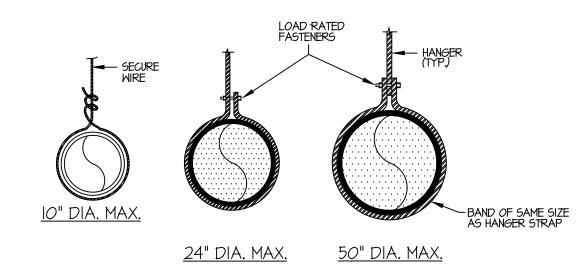

NOTE: HANGERS MUST NOT DEFORM DUCT SHAPE.

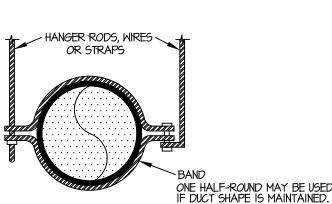

METHOD OF HANGING ROUND DUCTWORK

		(N.1.5.)		
DUCT DIAMETER	ROD DIAMETER	STRAP	WIRE DIAMETER	MAXIMUM SPACING
UP TO IO"	1/4"	1" X 22 ga.	ONE (1) 12 ga.	12'-0" O.C.
II" TO 18"	1/4"	I" X 22 ga.	TWO (2) 12 ga. ONE (1) 8 ga.	12'-O" O.C.
19" TO 24"	1/4"	I" X 22 ga.	TWO (2) 10 ga.	12'-O" O.C.
25" TO 36"	3/8"	1" X 20 ga.	TWO (2) 8 ga.	12'-O" O.C.
37" TO 50"	(2) 3/8"	TWO (2) 1" X 20 ga.	-	12'-0" O.C.
51" TO 60"	(2) 3/8"	TWO (2) 1" X 18 ga.	-	12'-O" O.C.
61" TO 84"	(2) 3/8"	TWO (2) 1" X 16 ga.	-	12'-O" O.C.

PIPING INSULATION NOTE: CONTRACTOR SHALL INSPECT ALL EXISTING HOT/CHILLED WATER PIPING INSULATION THROUGHOUT THE BUILDING, INCLUDING CRAWL SPACE AND REPAIR OR REPLACE INSULATION AS REQUIRED.


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CONNECT TO EXISTING

Revisions


Date Description 03-06-15 ISSUED FOR DCA FILING 03-18-15 ISSUED FOR BIDDING 03-27-15 ISSUED FOR DCA FILING & CONSTRUCTION ISSUED FOR ADDENDUM #1 04-07-15

Key Plan

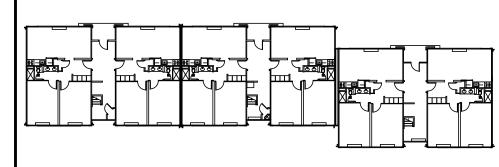

Consultants


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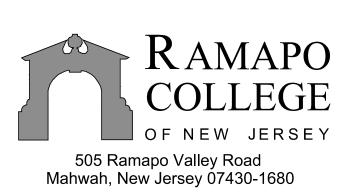
Project

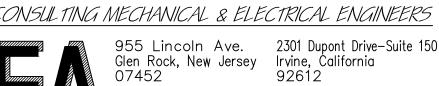INTERIOR RENOVATIONS MIMOSA - G RESIDENCE



DCA PROJECT# 9071-15

Client

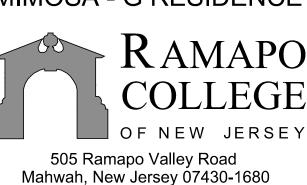

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Steven Napolitano, PE Cert /Lic No. Scale

HVAC NOTES, DETAILS AND SYMBOLS

Drawn By PS/Cadd

AS NOTED

l Michael T. Davina, P.E. | Robert J. Hatch, P.E. NJ #48654 CT #0025779 CA #E16118 CT #13318 MA #48516 NJ #30419 NV #019975 NY #56608


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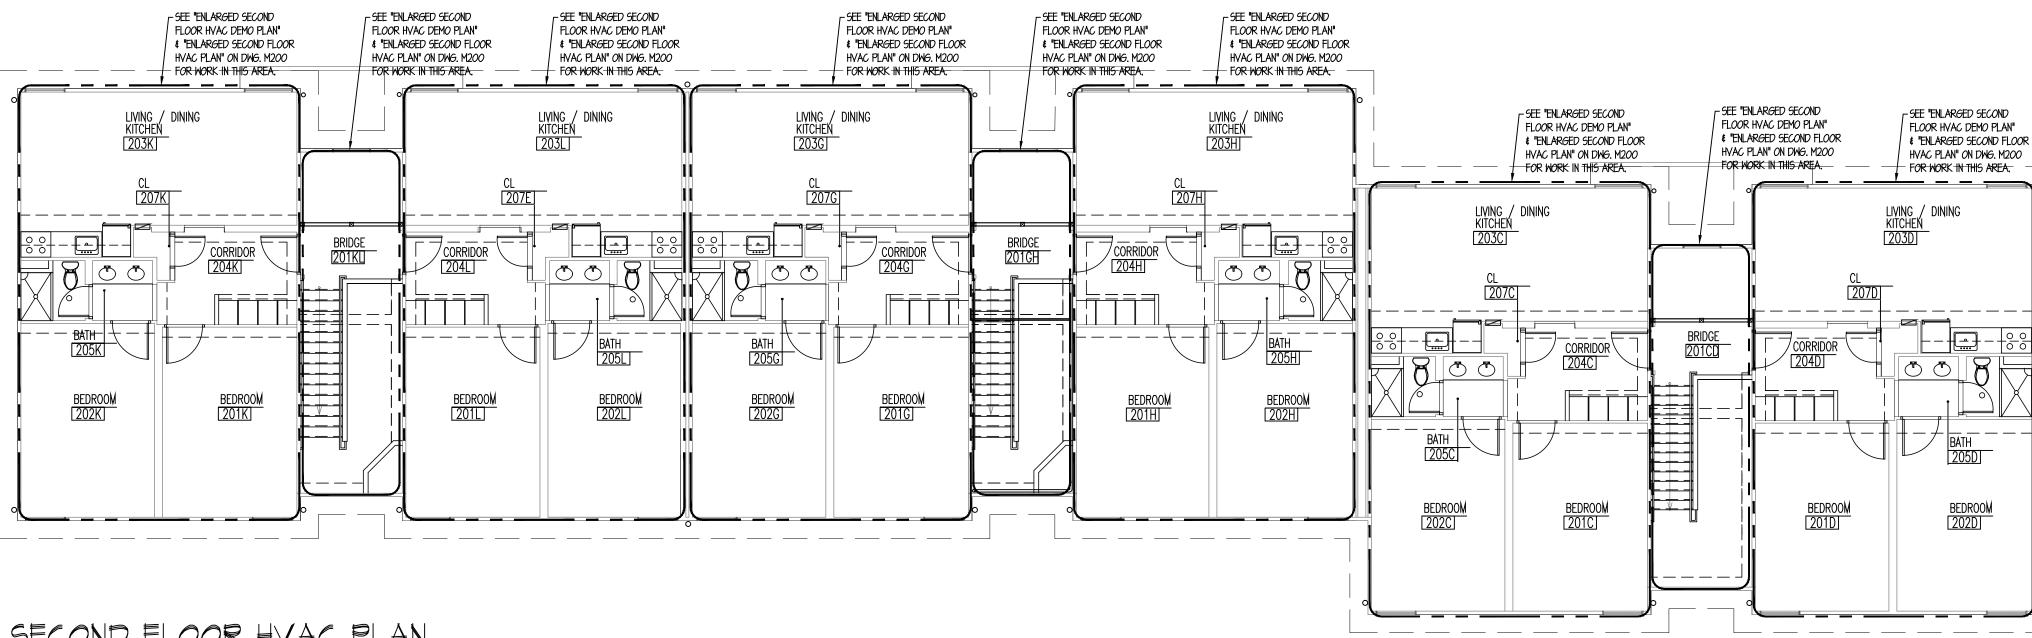
Dwg. No.

Checked By

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KEY NOTES: (1) 12"x12" LOWER DOOR BY 6.C. PROVIDE 8"x8" NECK SIZE, IO"XIO" FRAME SIZE WALL GRILLE MANUFACTURED BY RUSKIN MODEL "300RL" OR APPROVED EQUAL.



SECOND FLOOR HVAC PLAN SCALE: 1/8"=1'-0"

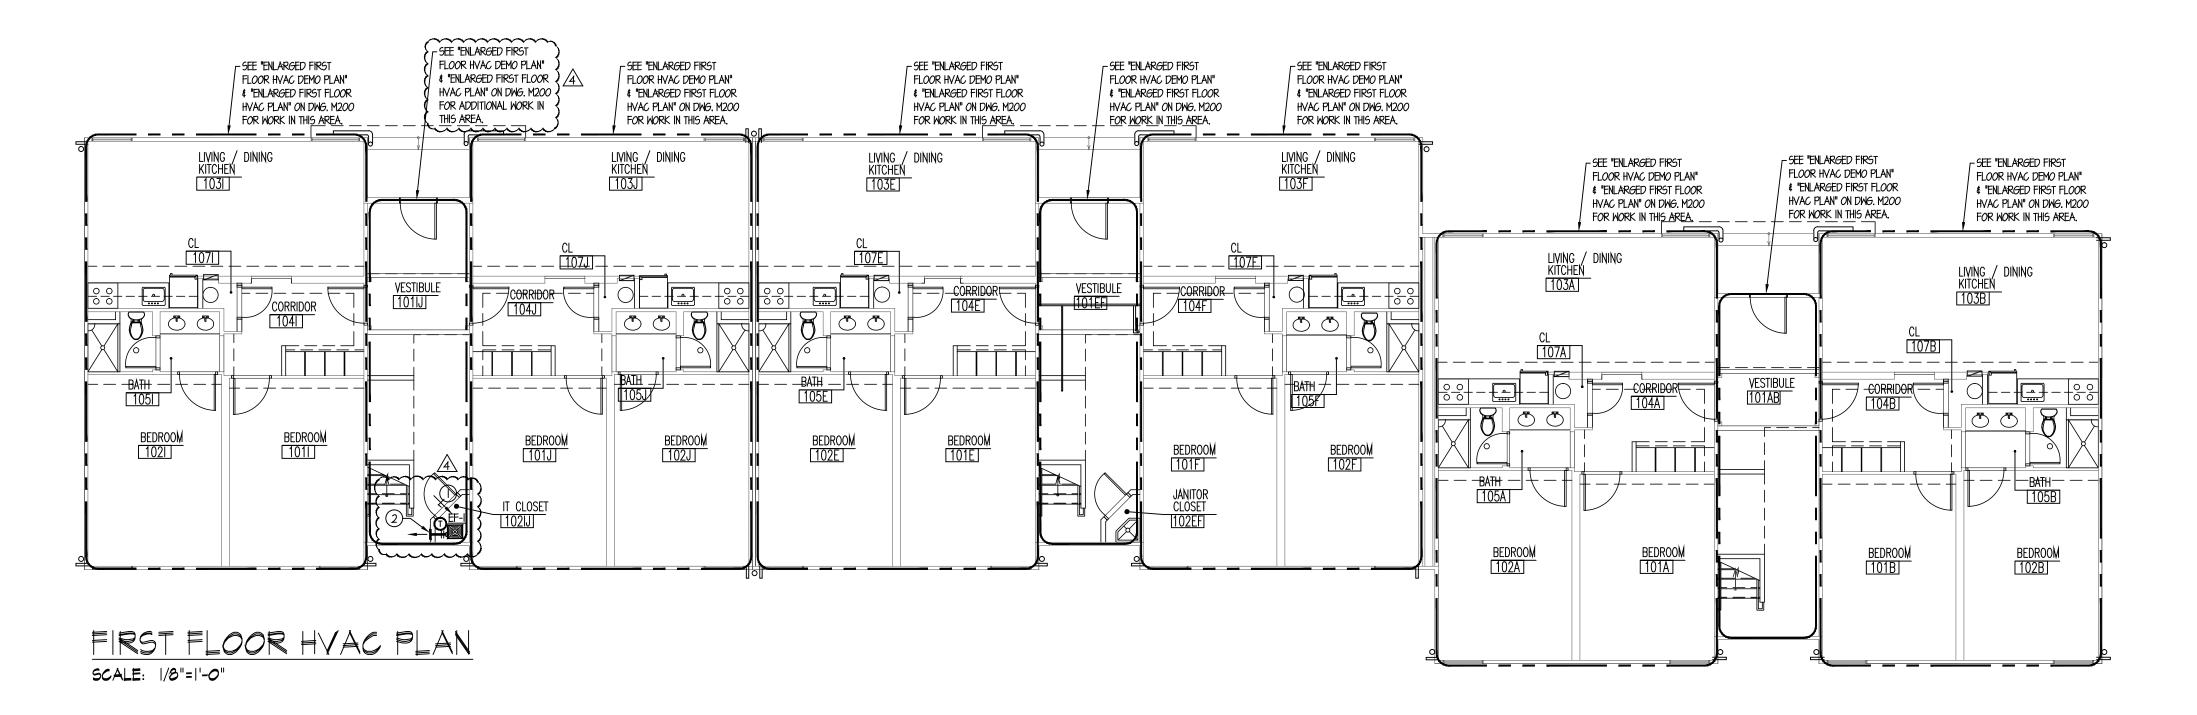3. PROVIDE WALL MOUNTED THERMOSTAT.

6. PROVIDE DESIGNER GRILLE.

4. PROVIDE FAN WITH SOLID STATE SPEED CONTROL.

5. PROVIDE HANGING BRACKETS AND SPRING ISOLATORS.


		GENERAL	-					FAN D	A T A	Мот	0 R	
JNIT NO.	SERVICE	LOCATION	MANUFACTURER MODEL No.	TYPE/ DESIGN	WEIGHT LBS,	TOTAL AIR QUANTITY	STAT. PRESS. (IN WG)	FAN RPM	TYPE DRIVE	MIN. SIZE (H.P.)	VOLT PHASE CYCLE	REMARKS
EF-I	IT CLOSET	SEE DWG.	GREENHECK SP-A390	CEILING	25	300	0.25	1153	DIRECT	150 M	115/1/60	SEE NOTES: 1, 2, 3, 4, 5, 6

Michael T. Davina, P.E. Robert J. Hatch, P.E. NJ #48654 CT #0025779 AR #13868 CA #E16118 MA #48516 NJ #30419 NV #019975 NY #56608 PA #036014-E

Revisions

Description

ISSUED FOR DCA FILING ISSUED FOR BIDDING 03-18-15 ISSUED FOR DCA FILING & CONSTRUCTION 03-27-15 04-07-15 ISSUED FOR ADDENDUM #1

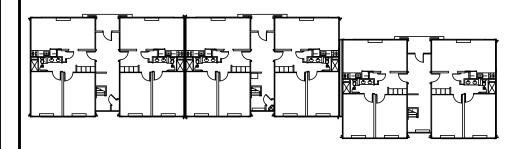

Consultants

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CONSULTING MECHANICAL & ELECTRICAL ENGINEERS 201.857.3998 t: 714.424.0001 201.857.3994 f: 714.424.0004 www.linwoodengineering.com

INTERIOR RENOVATIONS AT THE MIMOSA - G RESIDENCE




DCA PROJECT# 9071-15






Fay W. Logan, AIA John M. Lignos, AIA Lorin J. Sonenshine, AIA

Steven Napolitano, PE O

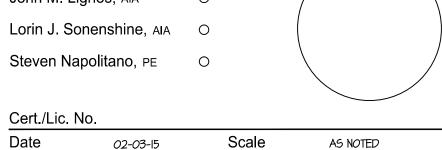


Date 02-03-15 Checked By MD Drawn By PS/Cadd FIRST & SECOND FLOOR HVAC PLANS


Work Order No. Dwg. No.

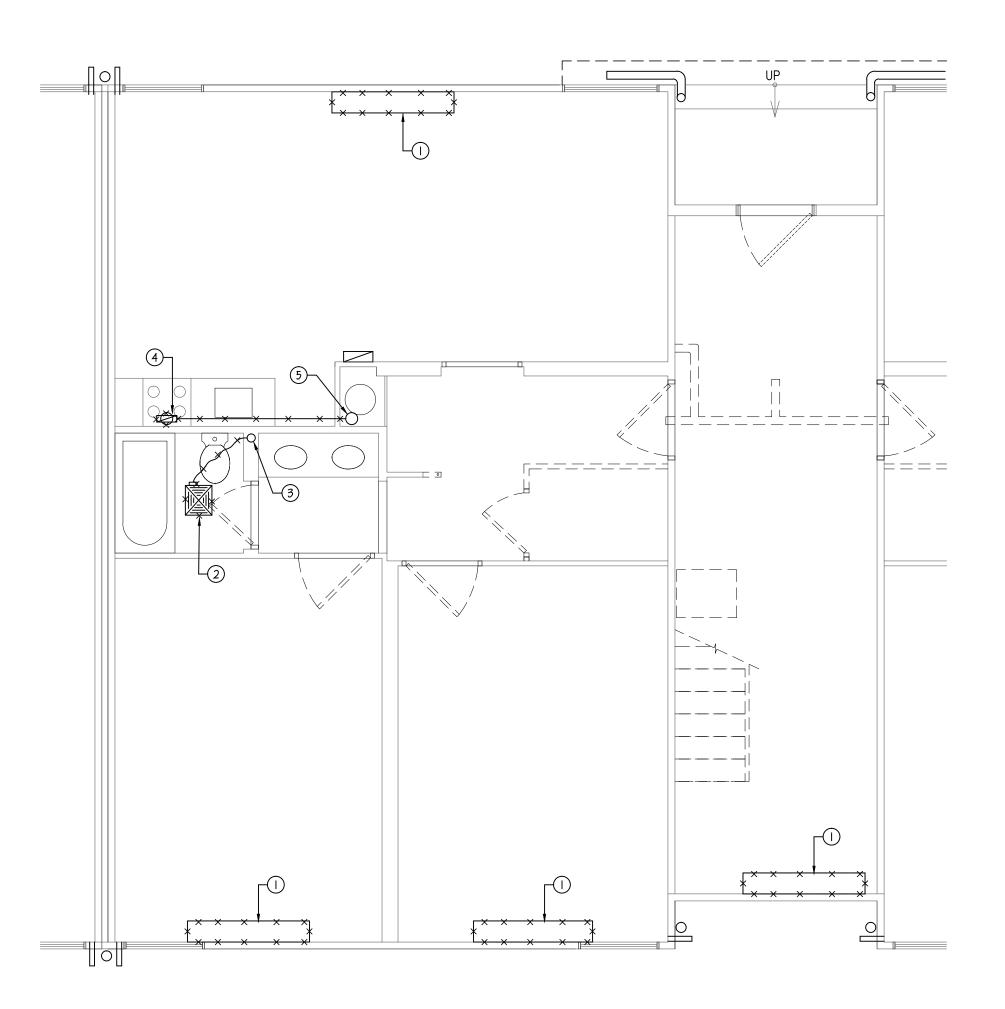


ENLARGED FIRST FLOOR HVAC DEMO PLAN SCALE: 1/4"=1'-0"

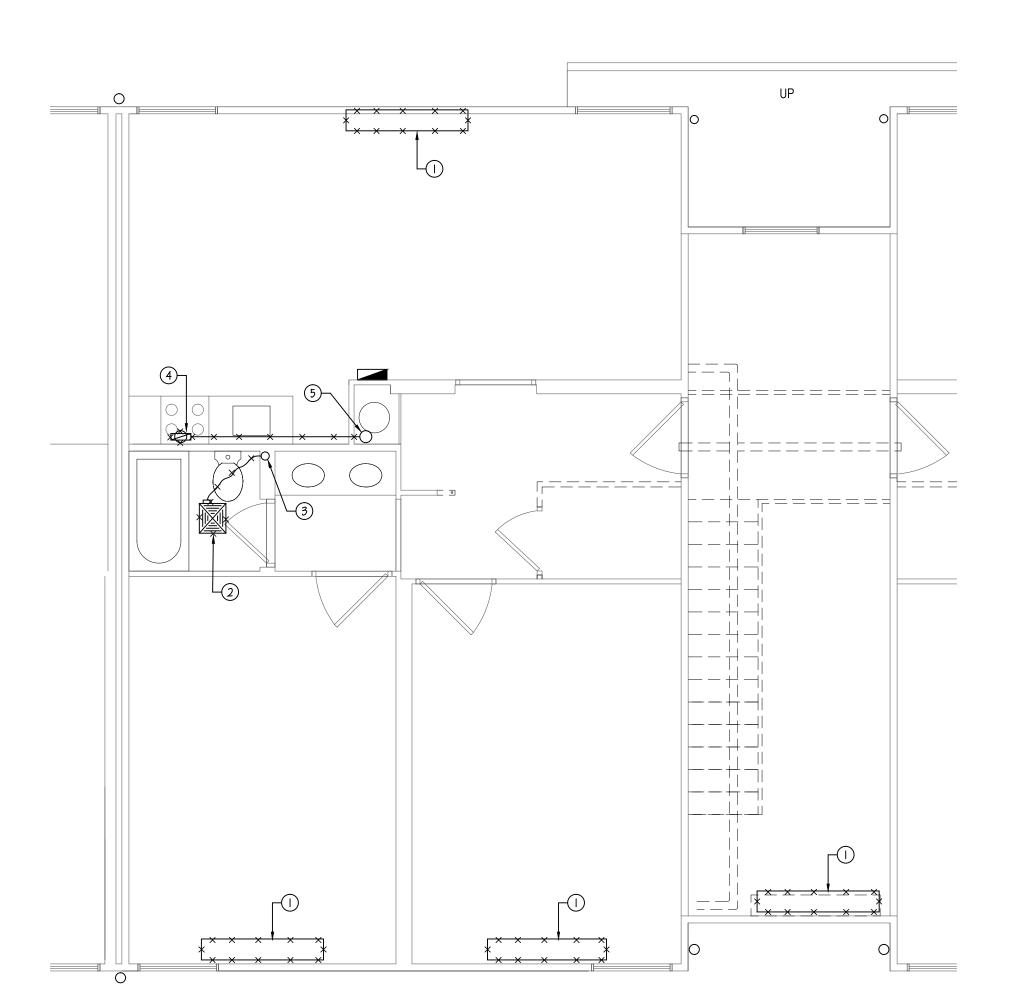

ENLARGED SECOND FLOOR HVAC DEMO PLAN SCALE: 1/4"=1'-0"

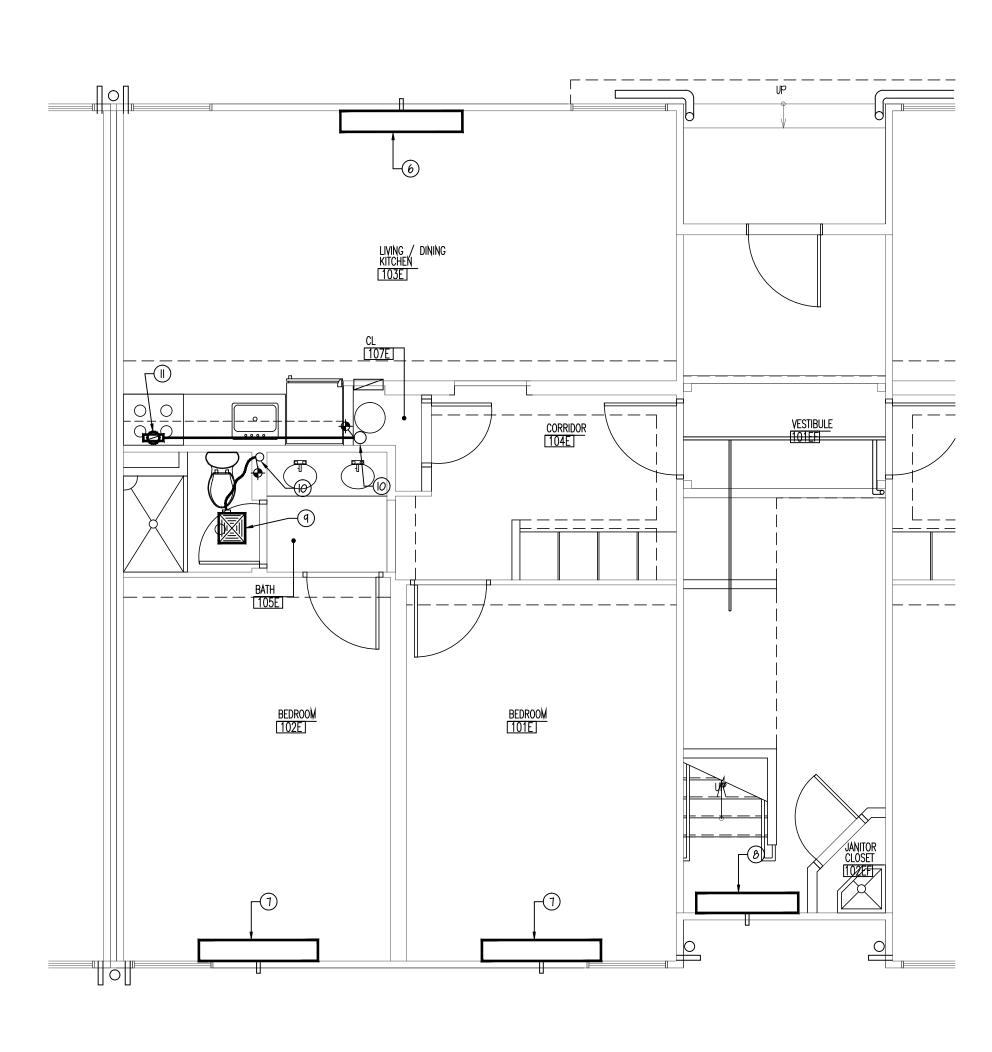

ENLARGED FIRST FLOOR HVAC PLAN SCALE: 1/4"=1'-0"

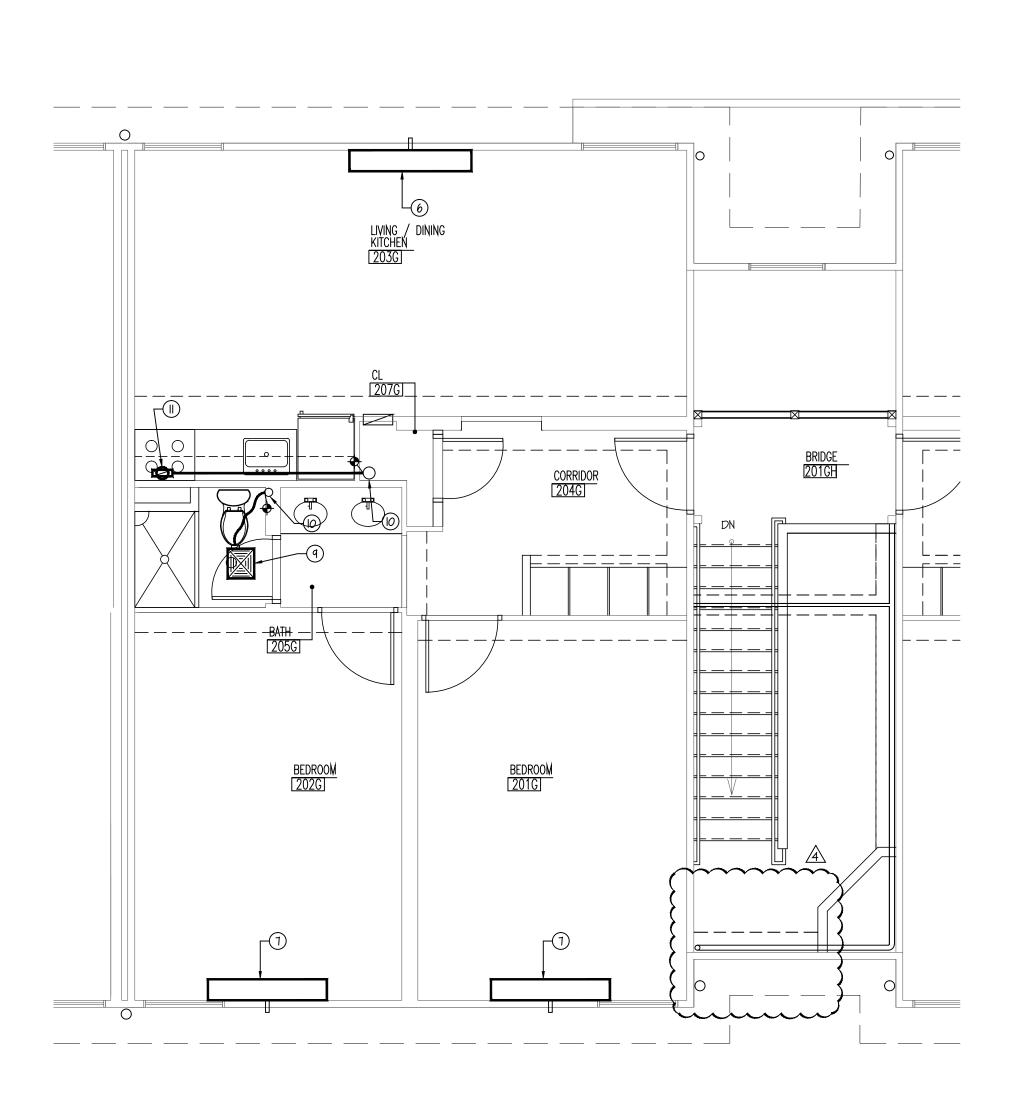

ENLARGED SECOND FLOOR HVAC PLAN SCALE: 1/4"=1'-0"

KEY NOTES:


- REMOVE EXISTING FAN COIL UNIT.


 REMOVE EXISTING TOILET EXHAUST FAN AND
- 3 EXISTING 4" OT TOILET EXHAUST DUCT RISER TO
- 4 REMOVE EXISTING HOOD EXHAUST DUCT.

 (5) EXISTING 6" HOOD EXHAUST DUCT RISER TO
- REMAIN.

 (b) NEW FAN COIL UNIT MANUFACTURED BY TRANE MODEL "FCBB040IKAAAOHIGAB2M". RE-CONNECT PIPING TO FAN COIL UNIT AS REQUIRED. PROVIDE NEW COPPER DRAIN PIPE WITH COPPER
- ESCUTHEON AT EXTERIOR WALL.

 1 NEW FAN COIL UNIT MANUFACTURED BY TRANE MODEL "FCBB020IJAAAEHIGAB2M". RE-CONNECT PIPING TO FAN COIL UNIT AS REQUIRED. PROVIDE NEW COPPER DRAIN PIPE WITH COPPER ESCUTHEON AT EXTERIOR WALL.
- 8 NEW FAN COIL UNIT MANUFACTURED BY TRANE MODEL "FCBBO4OIKAAAOHIGAB2M". EXTEND AND RE-CONNECT PIPING TO FAN COIL UNIT AS REQUIRED. PROVIDE NEW COPPER DRAIN PIPE WITH COPPER ESCUTHEON AT EXTERIOR WALL. CONTRACTOR TO PATCH AND REPAIR EXISTING DRAIN PENETRATION TO MATCH EXISTING.
- (4) NEW EXHAUST FAN MANUFACTURED BY BROAN MODEL "679" TO CONNECT TO EXISTING DUCT RISER WITH 4" FLEXIBLE DUCT.
- (O) SEAL ALL JOINTS IN EXISTING TOILET AND KITCHEN EXHAUST DUCT RISER WITH NEW MASTIC.
- NEW 10"x3-1/4 DUCT TRANSITION TO 6"\$ TO RUN IN CEILING TO CONNECT TO EXISTING EXHAUST DUCT

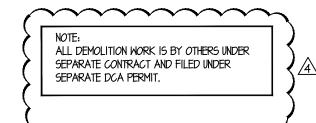


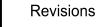

Date Issue Description

03-06-15 1 ISSUED FOR DCA FILING 03-18-15 2 ISSUED FOR BIDDING

03-27-15 3 ISSUED FOR DCA FILING & CONSTRUCTION 04-07-15 4 ISSUED FOR ADDENDUM #1

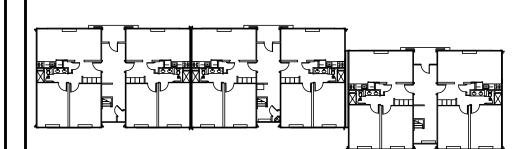

Consultants

Key Plan

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Proje

INTERIOR RENOVATIONS
AT THE
MIMOSA - G RESIDENCE



DCA PROJECT# 9071-15

Client



Architects & Engineers, PC


1 PARAGON DRIVE . MONTVALE . NEW JERSEY . 07645
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Fay W. Logan, AIA

John M. Lignos, AIA

Lorin J. Sopenshine, AIA

Lorin J. Sonenshine, AIA O
Steven Napolitano, PE O

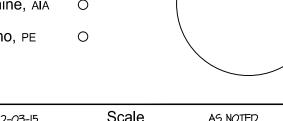

Date 02-03-15 Scale AS NOTED

Drawn By P5/Cadd Checked By MD

Dwg. Title

ENLARGED FIRST & SECOND FLOOR

Work Order No.

HVAC PLANS

Dwg. No.


Michael T. Davina, P.E.

NJ #48654
CT #00025779


Robert J. Hatch, P.E.

AR #13868
CA #E16118
CT #13318
FL #69560
MA #48516
NJ #30419
NV #019975
NY #56608


PA #036014-E

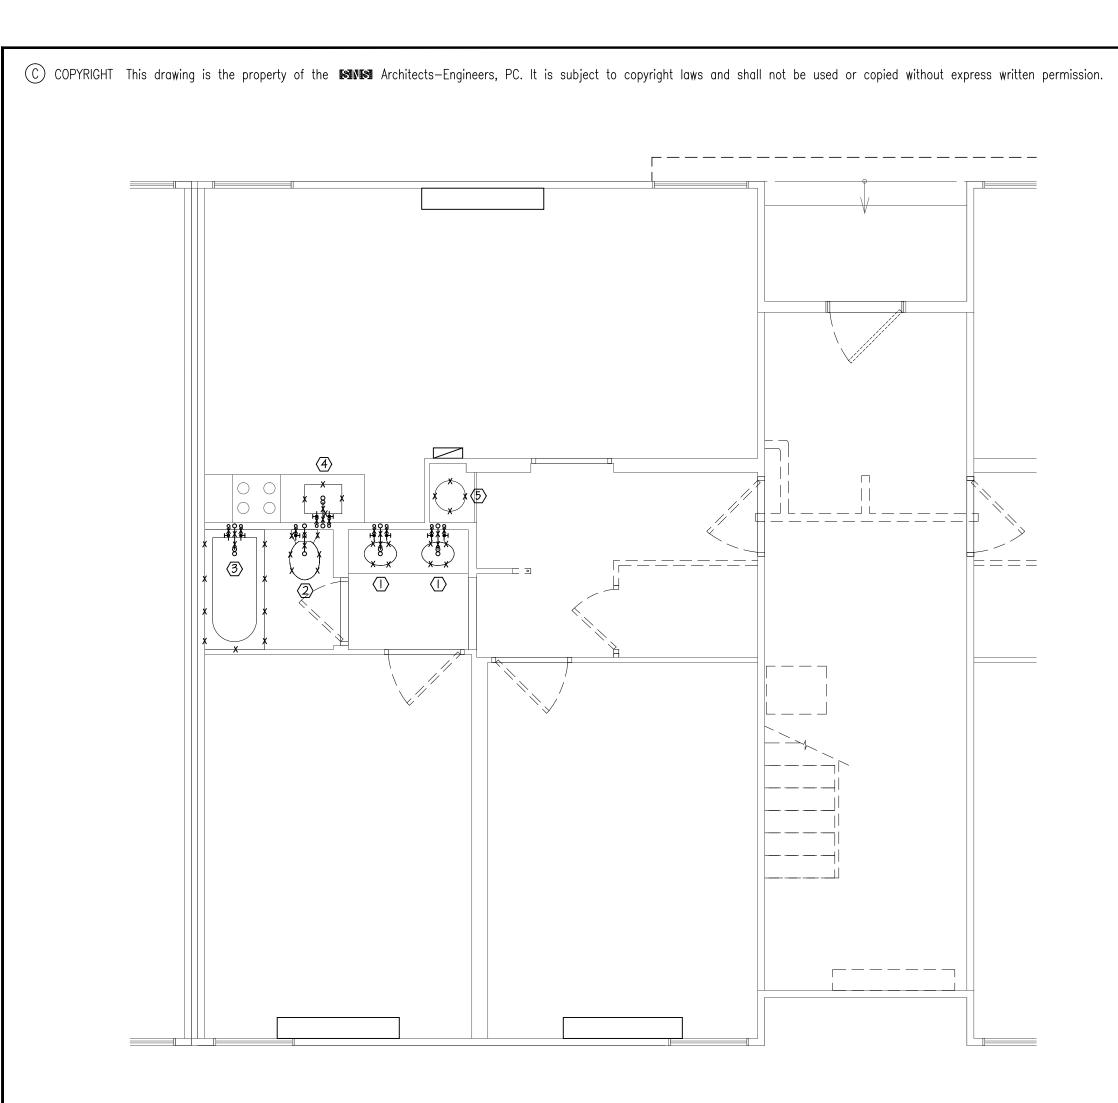


ENLARGED FIRST FLOOR PLUMBING DEMO PLAN SCALE: 1/4"=1'-0"

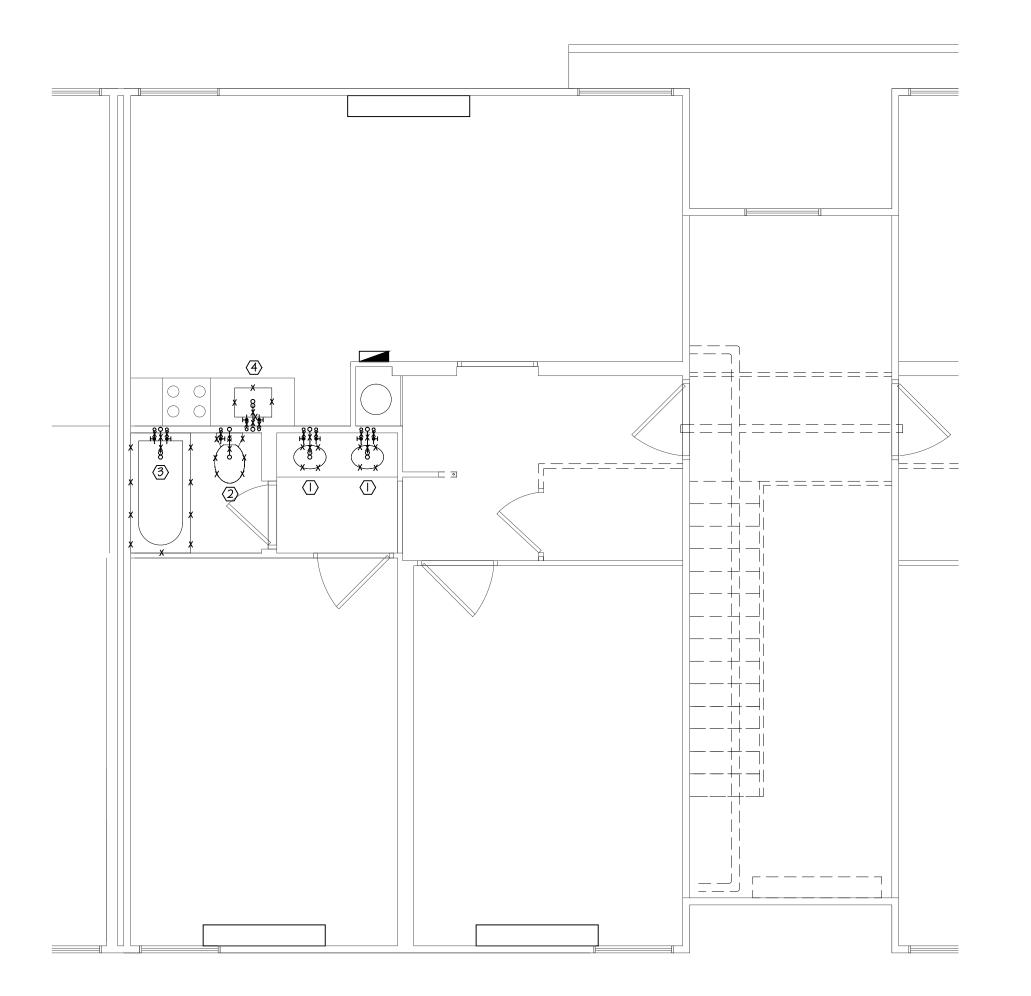

ENLARGED SECOND FLOOR PLUMBING DEMO PLAN SCALE: 1/4"=1'-0"

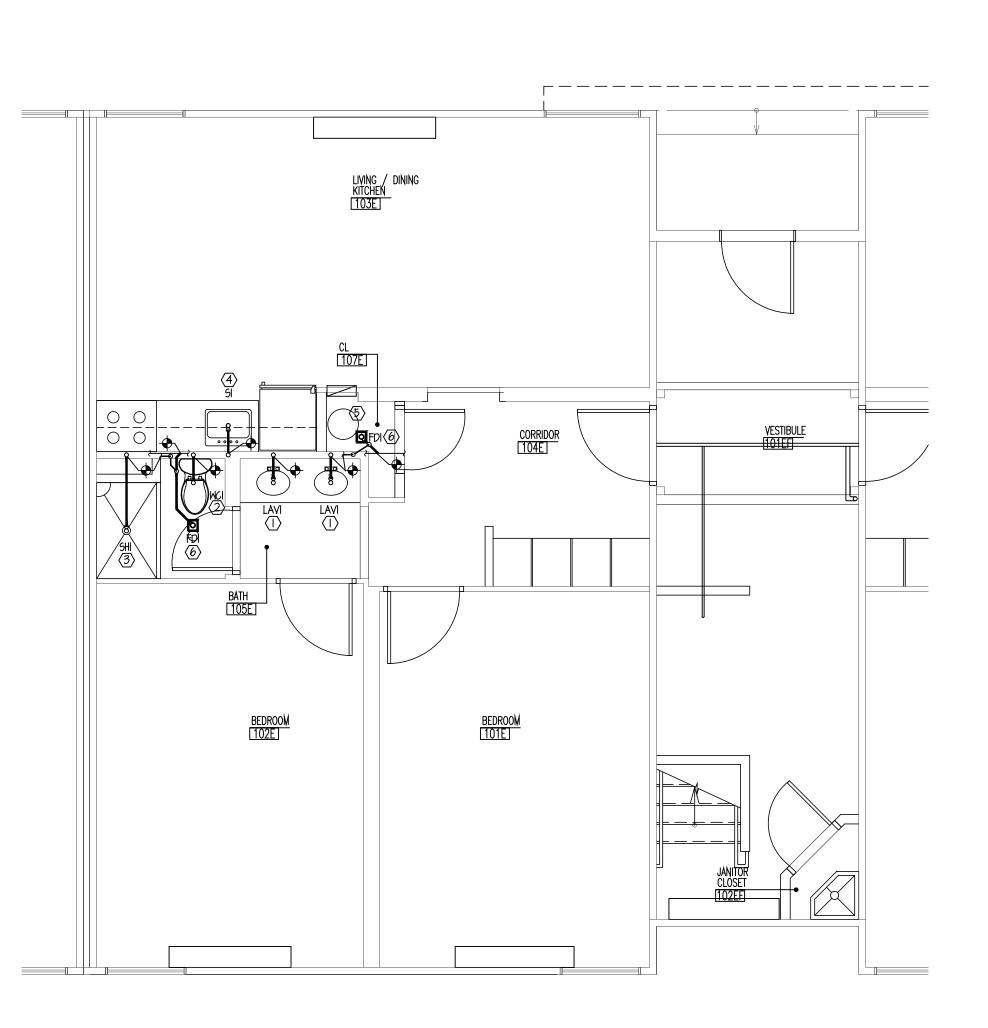


ENLARGED FIRST FLOOR SANITARY PLAN SCALE: 1/4"=1'-0"

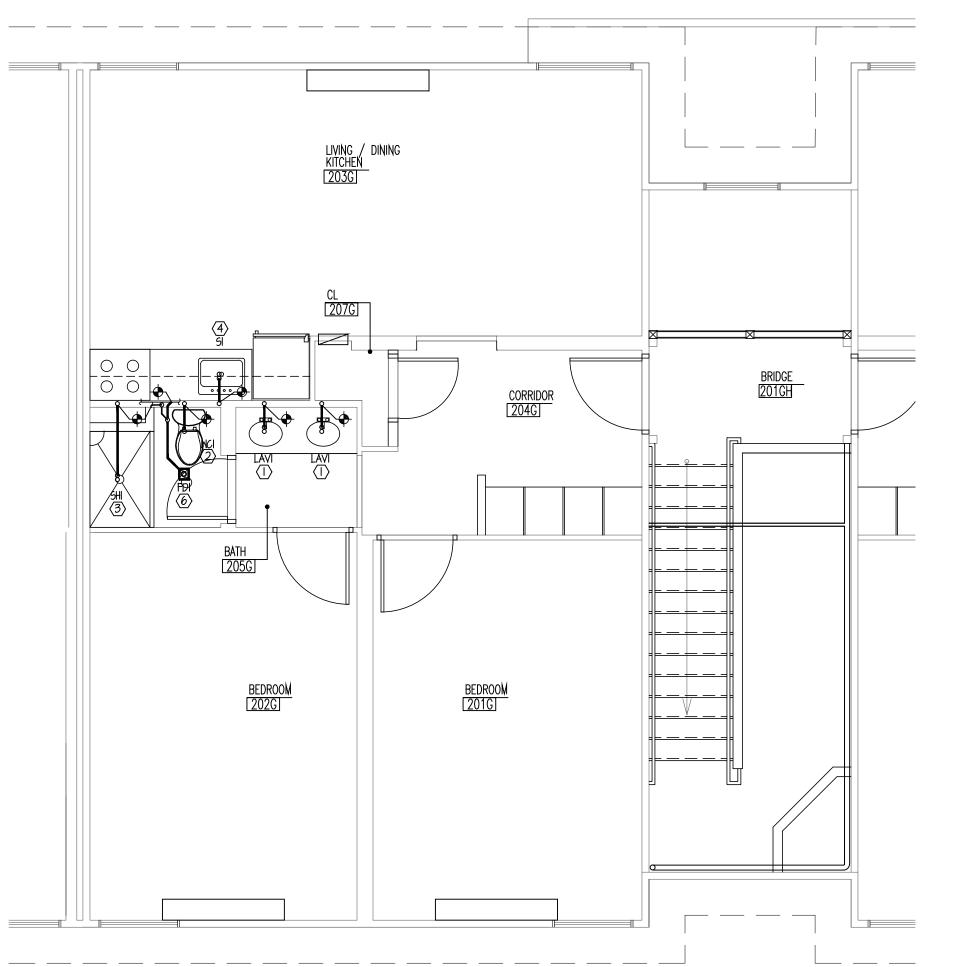


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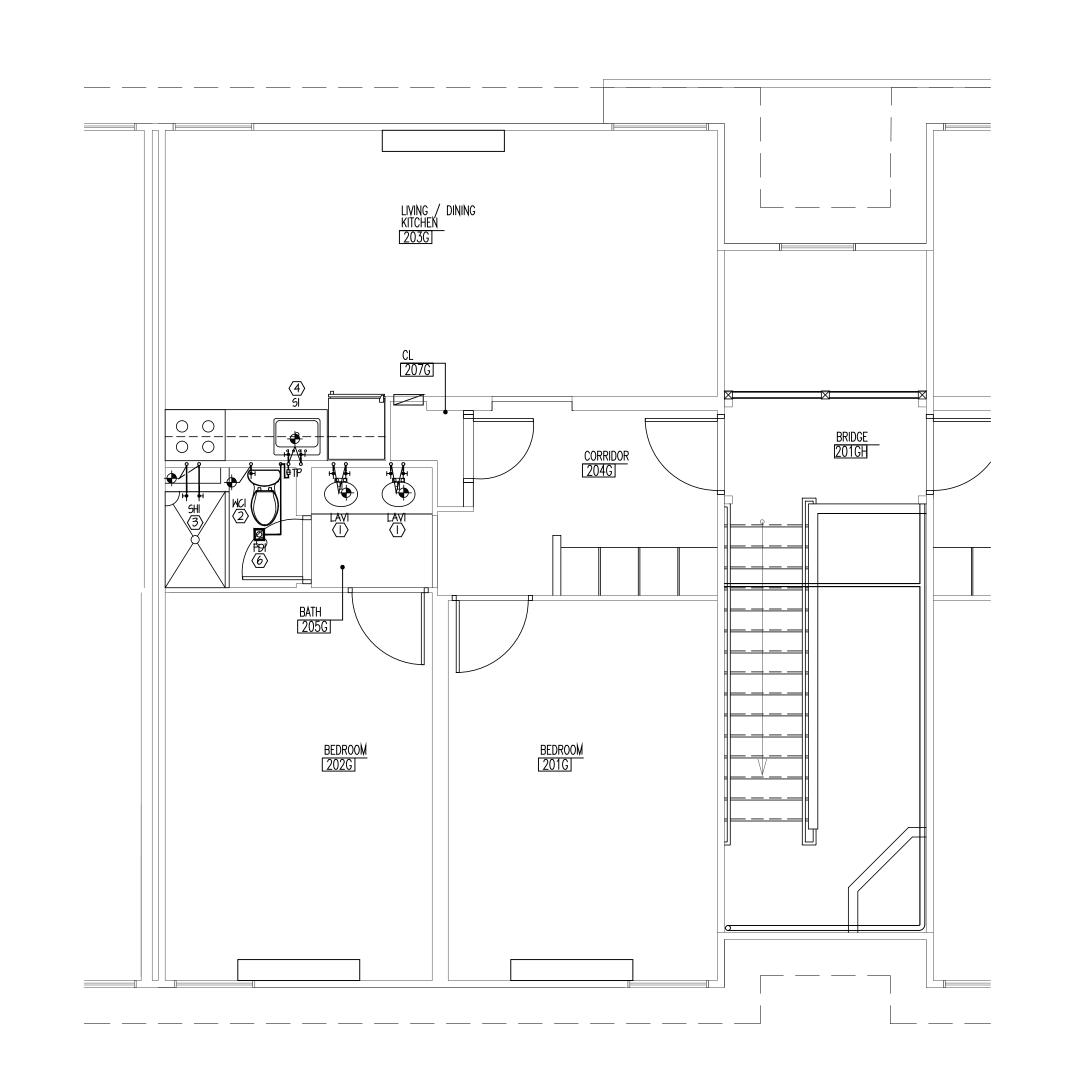


KEY NOTES (DEMO PLAN) EXISTING LAVATORY TO BE REMOVED. REMOVE EXISTING TRAP, TAIL PIECE, WASTE ARM, WALL ESCUTCHEON, FLEX SUPPLIES, STOP VALVES ETC. MODIFY EXISTING SANITARY, VENT AND DOMESTIC HOT AND COLD WATER LINES AS REQUIRED TO ALLOW FOR NEW FIXTURE. EXISTING FLOOR MOUNT WATER CLOSET TO BE REMOVED. REMOVE EXISTING FIXTURE, EXPOSED HARDWARE AND VALVES. MODIFY EXISTING SANITARY,

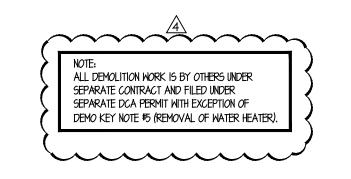
- VENT, DOMESTIC COLD WATER LINES, ETC. AS REQUIRED TO ALLOW FOR NEW
- 3) EXISTING BATHTUB TO BE REMOVED. REMOVE EXISTING HARDWARE AND VALVES, ETC. MODIFY EXISTING SANITARY, VENT AND DOMESTIC HOT AND COLD WATER LINES AS REQUIRED TO ALLOW FOR NEW SHOWER FIXTURE.
- A) EXISTING KITCHEN SINK TO BE REMOVED. REMOVE EXISTING TRAP, TAIL PIECE, WASTE ARM, WALL ESCUTCHEON, FLEX SUPPLIES, STOP VALVES ETC. MODIFY EXISTING SANITARY, VENT AND DOMESTIC HOT AND COLD WATER LINES AS REQUIRED TO ALLOW FOR NEW FIXTURE.
- EXISTING WATER HEATER TO BE REMOVED. MODIFY EXISTING DOMESTIC HOT AND COLD WATER LINES AS REQUIRED TO ALLOW FOR NEW WATER



ENLARGED FIRST FLOOR DOMESTIC WATER PLAN SCALE: 1/4"=1'-0"

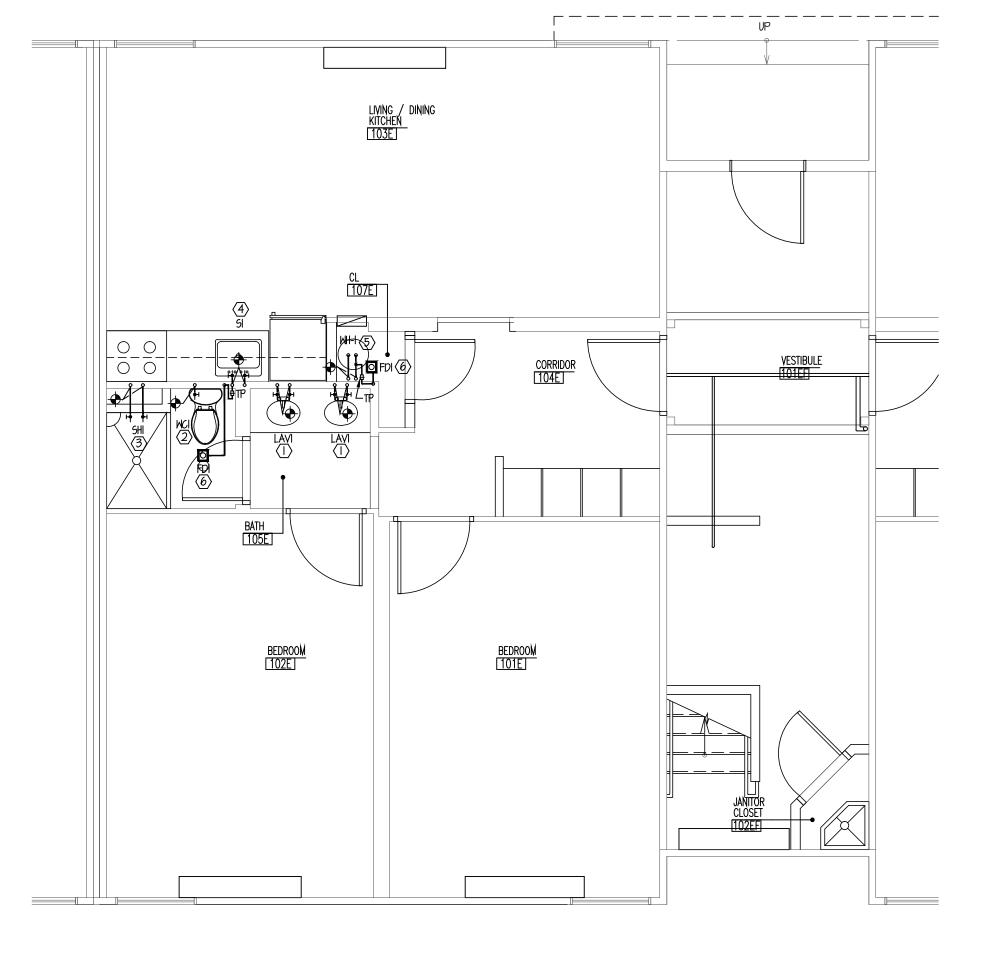

ENLARGED SECOND FLOOR DOMESTIC WATER PLAN SCALE: 1/4"=1'-0"

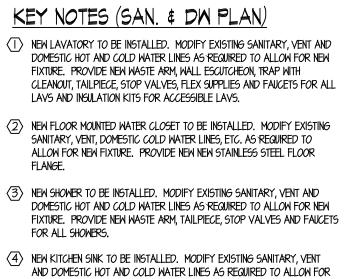

DOMESTIC COLD WATER LINES, ETC. AS REQUIRED TO ALLOW FOR NEW FLOOR DRAIN. PROVIDE FLOOR DRAIN WITH NEW TRAP PRIMER.

(4)	AND DOMESTIC HOT AND COLD WATER LINES AS REQUIRED TO ALLOW FOR NEW FIXTURE. PROVIDE NEW WASTE ARM, WALL ESCUTCHEON, TRAP WITH CLEANOUT, TAILPIECE, STOP VALVES, FLEX SUPPLIES AND FAUCET.		FL #	#13318 #69560 #48516 #30419
(5)	NEW HOT WATER HEATER TO BE INSTALLED. MODIFY EXISTING DOMESTIC HOT AND COLD WATER LINES AS REQUIRED TO ALLOW FOR NEW WATER HEATER. PROVIDE NEW VALVES, EXPANSION TANK, RELIEF VALVES, ETC.		NV NY	#019975 #56608 #036014-E
6	NEW FLOOR DRAIN TO BE INSTALLED. MODIFY EXISTING SANITARY, VENT,			


NJ #48654 CT #0025779

Michael T. Davina, P.E. Robert J. Hatch, P.E.

AR #13868

CA #E16118

ISSUED FOR BIDDING 03-27-15 ISSUED FOR DCA FILING & CONSTRUCTION 04-07-15 ISSUED FOR ADDENDUM #1

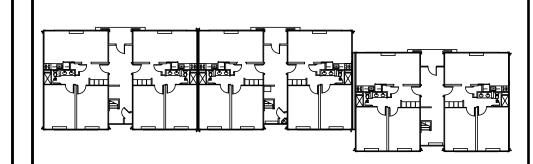

Consultants


LINWOOD ENGINEERING ASSOCIATES, P.A.

CONSULTING MECHANICAL & ELECTRICAL ENGINEERS 955 Lincoln Ave. 2301 Dupont Drive—Suite 150 Glen Rock, New Jersey Irvine, California 07452 92612 www.linwoodengineering.com

INTERIOR RENOVATIONS MIMOSA - G RESIDENCE




DCA PROJECT# 9071-15

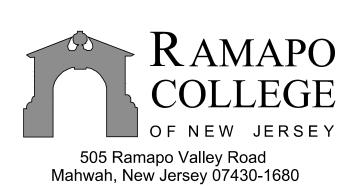



Fay W. Logan, AIA John M. Lignos, AIA Lorin J. Sonenshine, AIA O

Steven Napolitano, PE O

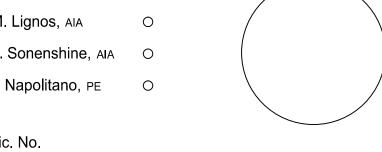

Cert./Lic. No. Scale 02-03-15 Checked By MD

Dwg. Title ENLARGED FIRST & SECOND FLOOR PLUMBING PLANS

Work Order No.

Dwg. No.


AS NOTED

INTERIOR RENOVATIONS AT THE

MIMOSA - G RESIDENCE



505 Ramapo Valley Road Mahwah, New Jersey 07430-1680

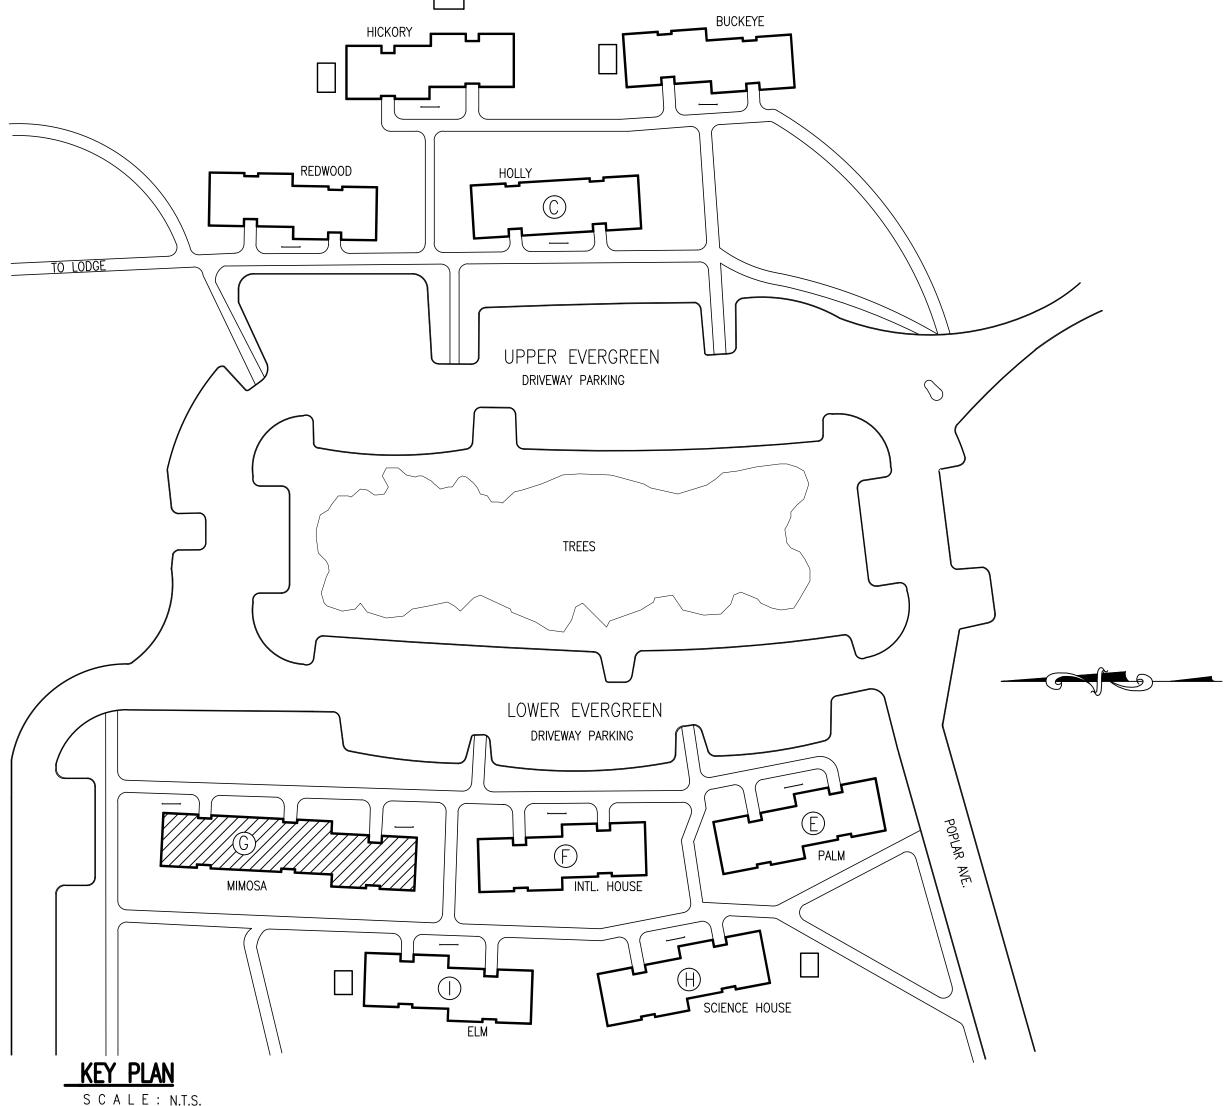

CONTROLLED INSPECTIONS

- 1. ALL SPECIAL INSPECTIONS, INCLUDING BUT NOT LIMITED TO, NEW STEEL, CONCRETE, MASONRY CONSTRUCTION, ETC, SHALL BE INSPECTED AS OUTLINED IN 2009 IBC/N.J. CHAPTER 17
- "STRUCTURAL TESTS AND SPECIAL INSPECTIONS". 2. OWNER SHALL HIRE A TESTING LAB TO PERFORM THE REQUIRED INDEPENDENT INSPECTIONS.

SAFETY PLAN NOTES

- 1. THE CONTRACTOR IS TO MAINTAIN ALL SERVICES TO THE BUILDING DURING THE PROGRESS OF THE WORK SPECIFIED FOR THE ALTERATION.
- 2. ALL MEANS OF EGRESS FROM THE BUILDING WILL BE KEPT FREE OF CONSTRUCTION OF ANY KIND. ALL ENTRANCE DOORS AND LIGHTS IN PUBLIC HALLWAYS WILL BE KEPT IN WORKING ORDER. THE CONTRACTOR SHALL PROVIDE ADEQUATE FIRE SAFETY TO

GENERAL NOTES

- I. CONTRACTOR SHALL VERIFY ALL DIMENSIONS AND EXISTING CONDITIONS AT THE SITE AND SHALL REPORT, IN WRITING, ANY DISCREPANCIES TO THE ARCHITECT PRIOR TO STARTING CONSTRUCTION. COMMENCEMENT OF THE WORK BY THE CONTRACTOR WILL IMPLY HIS ACCEPTANCE OF ALL EXISTING CONDITIONS. 2. EXISTING CONDITIONS DISTURBED BY ALTERATION WORK SHALL BE PATCHED & REPAIRED OR REPLACED TO MATCH EXISTING CONDITIONS & FINISHES TO A LIKE NEW CONDITION.
- 3. WHERE IN THE COURSE OF ALTERATION, DIMENSIONS EXIST OR CONDITIONS ARE ENCOUNTERED, WHICH ARE AT VARIANCE FROM THE EXISTING CONDITIONS AS SHOWN ON THE DRAWINGS, THE CONTRACTOR SHALL NOTIFY THE ARCHITECT OF SUCH DISCREPANCIES & SHALL NOT PROCEED UNTIL THE ARCHITECT DIRECTS
- THE PROPER METHOD OF COMPLETION. 4. CONTRACTOR TO CAP AND IDENTIFY ALL EXISTING UTILITIES PRIOR TO START OF WORK IN AREAS SUCH AS FLOORS, CEILINGS, PARTITIONS, ETC.; COORDINATE WITH ENGINEERING DRAWINGS. 5. CONTRACTOR SHALL PROVIDE PROPER PROTECTION FOR ALL EXISTING WORK, FURNISHINGS & FIXTURES

LIKELY TO BE DAMAGED. WHEN THE EXTERIOR OPENINGS ARE MADE IN EXISTING WORK, THEY SHALL BE

- COVERED w/WATERTIGHT PROTECTION AT THE END OF THE DAY'S WORK. 6. PROTECT EXISTING STRUCTURE FROM DAMAGE DURING CONSTRUCTION & INSURE STRUCTURAL INTEGRITY. LIMIT USE OF PREMISES FOR WORK AND FOR CONSTRUCTION OPERATIONS. LIMIT ACCESS AS DIRECTED BY
- BUILDING OWNER OR MANAGER. COORDINATE USE OF PREMISES UNDER DIRECTION OF BUILDING OWNER OR 8. FIRE RETARDANT TREAT ALL FINISHED WOOD, BLOCKING, ETC., PER CODE REQUIREMENTS. 9. MATERIALS, WORKMANSHIP AND INSTALLATION SHALL BE IN STRICT COMPLIANCE WITH NOT ONLY THE MFG'S PRINTED
- INSTRUCTIONS, BUT ALSO THE STANDARDS OF RECOGNIZED AGENCIES OR ASSOCIATIONS. 10. PROVIDE TEMPORARY PROTECTION OF MATERIALS AND EQUIPMENT.
- 11. ALL MATERIALS SHALL BE NEW, UNLESS OTHERWISE SPECIFIED.
- 12. WORK PERFORMED OVER ANY SURFACE CONSTITUTES ACCEPTANCE OF THAT SURFACE FOR THE SPECIFIED QUALITY OF THE WORK BEING PERFORMED THEREON.
- 13. ALUMINUM SURFACES IN CONTACT w/DISSIMILAR MATERIALS SHALL RECEIVE TWO (2) THOROUGH COATS OF
- 14. SHOP PRIME PAINT ALL NON-GALVANIZED FERROUS METALS. COLOR SHALL BE BLACK. 15. REFER TO ENGINEERING DRAWINGS PREPARED BY CONSULTING ENGINEER FOR ALL ELECTRICAL, MECHANICAL,
- AND SPRINKLER INFORMATION. 16. UPON COMPLETION OF THE WORK, REMOVE ANY TEMPORARY FACILITIES AND RESTORE ALL AREAS DISTURBED
- BY CONSTRUCTION OPERATIONS TO THEIR ORIGINAL CONDITION OR AS APPROVED BY ARCHITECT. 17. REUSE OF THIS DRAWING WITHOUT THE ARCHITECT'S PROFESSIONAL INVOLVEMENT WILL BE AT THE OWNER'S OR USER'S SOLE RISK AND WITHOUT LIABILITY TO THE ARCHITECT. THE OWNER OR USER SHALL INDEMNIFY AND HOLD HARMLESS THE ARCHITECT, THE ARCHITECT'S CONSULTANTS, AGENTS AND EMPLOYEES AGAINST ANY CLAIMS, DAMAGES, LOSSES AND EXPENSES,
- INCLUDING BUT NOT LIMITED TO ATTORNEY'S FEES.

 18. SHOP DRAWINGS & SUBMITTALS: REFER TO FRONT END SPECIFICATIONS PREPARED BY CAMBRIDGE FOR SHOP DRAWING & SUBMITTAL
- PROCEDURE & REQUIREMENTS 9. GENERAL CONTRACTOR SHALL PREPARE COORDINATION DRAWINGS AS REQUIRED TO RESOLVE CONFLICTS AND TO ASSURE COORDINATION OF WORK. SUBMIT COMPOSITE WORKING DRAWINGS AT A SUITABLE SCALE NOT
- LESS THAN 1/2"=1'-0" TO ARCHITECT FOR REVIEW. REPRODUCE AND DISTRIBUTE REVIEWED COPIES TO ALL CONCERNED PARTIES.

20. CLEANING:

- A. MAINTAIN PREMISES AND PUBLIC PROPERTIES FREE FROM ACCUMULATIONS OF WASTE, DEBRIS AND RUBBISH, CAUSED BY B. AT COMPLETION OF WORK, REMOVE WASTE MATERIALS, RUBBISH, TOOLS, EQUIPMENT, MACHINERY AND SURPLUS MATERIALS, AND CLEAN ALL SIGHT EXPOSED SURFACES: LEAVE PROJECT CLEAN AND FOR OCCUPANCY.
- A. WARRANTY WORK FREE FROM DEFECTIVE MATERIALS AND WORKMANSHIP FOR ONE YEAR AFTER THE DATE OF OWNER'S
- ACCEPTANCE OR WITHIN SUCH PERIOD OF TIME AS MAY BE PRESCRIBED BY THE TERMS OF ANY APPLICABLE SPECIAL WARRANTY REQUIRED BY THE CONTRACT DOCUMENTS.

 22. THE GENERAL CONTRACTOR & SUB CONTRACTOR SHALL FOLLOW CHAPTER 13 OF THE ASCE 7-05 FOR APPLICABLE SEISMIC
- REQUIRMENTS FOR FASTENING NON-STRUCTURAL COMPONENTS (I.E. SIGNGS, ELECTRICAL, MECHANICAL, HVAC, TV MONITORS), ALL FASTENERS SHALL BE IN COMPLIANCE W/ THE REQUIRMENTS.

GENERAL NOTES (CONT.)

- 23. THE CONTRACTOR WILL BE RESPONSIBLE THAT ALL WORK IS IN STRICT ACCORDANCE WITH LOCAL BUILDING CODES. 24. GYPSUM BOARD PARTITIONS SHALL BE ERECTED AS SHOWN ON THE PLANS, DETAILS, OR AS CALLED FOR IN THE SPECIFICATIONS. GYPSUM BOARD PARTITION JOINTS SHALL BE LOCATED SO THAT THE PANEL EDGES FALL ON ALTERNATE STUDS. JOINTS SHALL BE TAPED, SPACKLED AND FINISHED SMOOTH FOR RECEPTION OF NEW FINISHES.
- 25. WHERE NEW AND EXISTING BUILDING PARTITIONS ARE SHOWN TO ALIGN, THE JUNCTION SHALL BE TAPED, SPACKLED AND
- 26. CORNER AND 'J' BEADS SHALL BE USED AT EXPOSED GYPSUM BOARD CORNERS AND/OR ENDS. 27. THOROUGHLY CHECK JOBSITE FOR EXISTING DAMAGED FRAMING. SUCH CONDITIONS SHALL BE REPAIRED AND SURFACES MADE
- READY TO RECEIVE NEW FINISHES. INCLUDE SUCH CONDITIONS IN BASE BID. 28. WALLS THAT ARE TO BE PAINTED SHALL HAVE ONE (1) COAT OF PRIMER AND MINIMUM OF TWO (2) FINISH COATS OR UNTIL 4 THOROUGHLY COVERED, REFER TO C/M DRAWINGS FOR FURTHER INFORMATION. 29. THE CONTRACTOR SHALL BE RESPONSIBLE FOR COORDINATING WITH THE CONSULTANTS DRAWINGS BEFORE PROCEEDING WITH THE WORK. ANY DISCREPANCY BETWEEN ARCHITECTS CONSULTING ENGINEER'S DRAWINGS AND THE CONSULTANTS DRAWINGS
- SHALL BE BROUGHT TO THE ATTENTION OF THE ARCHITECT FOR CLARIFICATION PRIOR TO THE INSTALLATION OF SAID WORK. ANY WORK INSTALLED IN CONFLICT WITH THE ARCHITECTURAL AND M.E.P. ENGINEERING DRAWINGS SHALL BE CORRECTED BY THE CONTRACTOR AT HIS EXPENSE WITHOUT EXPENSE TO THE OWNER. IN THE EVENT OF DISCREPANCY THE CONTRCTOR SHALL BE DEEMED TO HAVE INCLUDED IN THE BID THE GREATER, BETTER QUALITY ETC. SEE LIST OF DRAWINGS FOR CONSULTANT &
- 30. IN THE EVENT OF INCONSISTENCY BETWEEN DRAWINGS AND SPECIFICATION OR WITHIN EITHER DOCUMENT NOT CLARIFIED BY ADDENDUM, THE BETTER QUALITY OR GREATER QUANTITY OF WORK SHALL BE PROVIDED IN ACCORDANCE WITH THE ARCHITECT'S 31. ARCHITECT HAS NO KNOWLEDGE OF ANY OTHER HAZARDOUS MATERIALS ON THE SITE. SHOULD ASBESTOS OR OTHER
- HAZARDOUS MATERIALS BE ENCOUNTERED DURING DEMOLITION ACTIVITIES, CONTACT OWNER AND COMPLY WITH APPLICABLE REGULATIONS, LAWS AND ORDINANCES CONCERNING REMOVAL, HANDLING AND PROTECTION AGAINST EXPOSURE OR _ENVIRONMENTAL_POLLUTION:_____ CONTRACTOR SHALL BE RESPONSIBLE FOR PROVIDING PROTECTION OF THE SPACE UNTIL OCCUPANCY IS TAKEN. ALL
- PROTECTION SHALL BE MAINTAINED DAILY.

 33. THE CONTRACTOR WILL BE RESPONSIBLE FOR BRINGING IN AND REMOVING ALL MATERIALS AND EQUIPMENT. 34. THE CONTRACTOR SHALL OBTAIN, PAY FOR AND MAINTAIN IN FORCE DURING THE ENTIRE PROGRESS OF THE WORK INSURANCE
- FOR PUBLIC LIABILITY, WORKMAN'S COMPENSATION AND DISABILITY IN THE AMOUNTS AS REQUIRED BY LAW, AS A MINIMUM. 35. THE CONTRACTOR SHALL BE RESPONSIBLE FOR CHECKING WITH THE ARCHITECTURAL DRAWINGS BEFORE PROCEEDING WITH THE INSTALLATION OF ANY MECHANICAL, ELECTRICAL, OR SPRINKLER WORK. ANY DISCREPANCY BETWEEN ARCHITECTS AND CONSULTING ENGINEER'S DRAWINGS AND SPECIFICATIONS SHALL BE BROUGHT TO THE ATTENTION OF THE ARCHITECT FOR CLARIFICATION PRIOR TO INSTALLATION OF SAID WORK. ANY WORK INSTALLED IN CONFLICT WITH THE ARCHITECTURAL DRAWINGS SHALL BE CORRECTED BY THE CONTRACTOR AT HIS EXPENSE AND AT NO ADDITIONAL EXPENSE TO THE OWNER. IN THE EVENT OF A DISCREPANCY THE CONTRACTOR SHALL BE DEEMED TO HAVE INCLUDED IN THE BID THE GREATER QUANTITY, BETTER
- 36. G.C. SHALL PROVIDE FIRE EXTINGUISHERS W/SEMI-RECESSED CABINET AS REQUIRED BY LOCAL CODES. USE TYPE ABC/SR 10 LB. ABC UL RATED, FM APPROVED COMMERCIAL GRADE FIRE EXTINGUISHER W/METAL_VALVE, PRESSURE GAGE, INSTRUCTIONS,/ SAFETY PIN & BREAKABLE TYPE SEAL. MOUNT IN SEMI-RECESSED F.E. CABINET, LARSEN'S ST. STL. MODEL SS-2409-R1 // 4 \
 CABINET. MOUNT PER ANSI AND ADA REQUIREMENTS. REVIEW ADDITIONAL LOCATIONS IF REQUIRED WITH ARCHITECT & BUILDING
- FIRE INSPECTOR PRIOR TO INSTALLATION. 37. DETAILS NOT SHOWN OR SPECIFIED, BUT NECESSARY FOR PROPER AND ACCEPTABLE CONSTRUCTION, INSTALLATION OR OPERATION OF ANY PART OF THE WORK AS DETERMINED BY THE ARCHITECT. SHALL BE INCLUDED IN THE WORK THE SAME AS
- 38. THE WORDS 'PROVIDE OR PROVIDE NEW' MEANS TO FURNISH AND INSTALL NEW ITEM(S) AND/OR SYSTEM(S) INDICATED. 39. TRADE CONTRACTOR SHALL BE RESPONSIBLE FOR ADEQUATELY BRACING AND PROTECTING ALL WORK DURING CONSTRUCTION AGAINST DAMAGE, BREAKAGE, COLLAPSE, DISTORTIONS, AND OFF ALIGNMENTS ACCORDING TO CODES AND STANDARDS OF GOOD
- 40. CONTRACTORS SHALL LAYOUT HIS OWN WORK AND VERIFY ALL DIMENSIONS REQUIRED FOR OTHER TRADES WITH THE
- 41. CONTRACTOR SHALL MAINTAIN FREE AND UNOBSTRUCTED ACCESS FROM WORK AREA AND ADJACENT SPACES TO THE OUTSIDE OF THE BUILDING AT ALL TIMES. IF THE PATHS OF EGRESS CANNOT BE MAINTAINED DURING THE CONSTRUCTION, THE CONTRACTOR MUST PROVIDE ALTERNATE MEANS OF EGRESS INCLUDING ERECTING BARRICADES, TEMPORARY SIGNS, ALTERNATE PATHS OF TRAVEL, ETC. IN ORDER TO MAINTAIN A SAFE ENVIRONMENT FOR THE OCCUPANTS OF THE BUILDING.
- 42. WHERE MANUFACTURER'S NAMES AND PRODUCT NUMBERS ARE INDICATED ON THE DRAWINGS IT SHALL BE CONSTRUED TO MEAN THE ESTABLISHING OF QUALITY AND PERFORMANCE STANDARDS OF SUCH ITEMS. ALL OTHER PRODUCT SUBSTITUTIONS MUST BE SUBMITTED TO THE ARCHITECT FOR APPROVAL 43. THE CONTRACTOR IS RESPONSIBLE FOR CONSTRUCTION MEANS METHODS, TECHNIQUES, SECUENCES AND PROCEDURES, AND FOR
- 44. THE CONTRACTOR IS TO INSTALL NEW TELECOMMUNICATIONS SYSTEM, INCLUDING NEW WIRING, JACKS & EQUIPMENT

THE COORDINATION OF WORK, AND FOR PERFORMED BY HIS SUBCONTRACTOR.

LEGEND/ SYMBOLS

EXISTING PARTITION TO REMAIN EXISTING PARTITION TO BE REMOVED

EXISTING PARTITION TO BE MODIFIED NEW PARTITION TYPE

EXISTING DOOR & FRAME TO REMAIN EXISTING DOOR & FRAME TO BE

REMOVED NEW DOOR- FIRST NUMBER INDICATES FLOOR- SEE DOOR SCHEDULE

'∐6" TYP. (U.O.N.)

COLUMN REFERENCE GRID

REFERENCE DWG. No.

ROOM No. - FIRST NUMBER INDICATES FLOOR FINISH CODE REFERENCE POINT / DATUM POINT

EXIT LIGHT BLANKET INSULATION

WOOD BLOCKING IN SECTION

LIST OF ABBREVIATIONS

<u>0</u>	AT
Ä.D.	AREA DRAIN
ACOUS	ACOUSTIC
\.F.F.	ABOVE FINISHED FLOOR
ARCH	ARCHITECT
ARCH'L	ARCHITECTURAL
ALUM	ALUMINUM
SD SD	BOARD
BLK	BLOCK
BLDG	BUILDING
BLKG	BLOCKING
3/0	BOTTOM OF
∑.J.	CONTROL JOINT
CL CLG	CLOSET
CLG	CEILING
COL	COLUMN
CONC	CONCRETE
CONT	CONTINUOUS
CONTR	CONTRACTOR
CONST	CONSTRUCTION
C.T.	CERAMIC TILE
DET DIM	DETAIL DIMENSION
ON	DOWN
0.0.	DOOR OPENING
OWG	DRAWING
Ā	EACH
EA EL	ELEVATION
ELEC	ELECTRIC
EQ	EQUAL
E.W.C.	ELECTRIC WATER COOLER
EXH	EXHAUST
XP. JT.	EXPANSION JOINT
<u>-</u> XI	EXTERIOR
F.D.	FLOOR DRAIN
FLUR	FLUORESCENT
F.H.C. FIN	FIRE HOSE CABINET FINISH
F.P.S.C.	FIREPROOF SELF-CLOSING
.1 .5.0. FR	FRAME
w.c.	FABRIC WALL COVERING
GA	GAGE, GAUGE
GB	GRAB BAR
GL	GLASS
GYP. BD.	GYPSUM WALLBOARD
4	HIGH
НB	HOSE BIBB
HDW	HARDWARE
HGT	HEIGHT
13.4	LIOLLOW METAL

HOLLOW METAL

HOT WATER HEATER

INSIDE DIAMETER

HEATING/VENTILATING/

AIR CONDITIONING

HORIZONTAL HOUR

INSULATION

INTERIOR

ON CENTER OUTSIDE DIAMETER OVERFLOW DRAIN OVERHEAD OPPOSITE HAND OPPOSITE PLASTIC LAMINATE PLYWOOD PAPER TOWEL DISPENSER PAPER TOWEL DISPENSER AND RECEPTACLE REFRIGERATOR REQUIRED ROUGH OPENING SOAP DISPENSER SECTION SQUARE FOOT SANITARY NAPKIN DISPENSER STAND PIPE SPECIFICATION (s stainless steèl STANDARD STRUCTURE **STRUCTURAL** SUSPENDED **TELEPHONE**

LAVATORY

LOW POINT

MECHANICAL

MASONRY OPENING

NOT IN SCOPE

MOP & BROOM RACK

LEADER

WITH TRIMMED OPENING TOP OF TOILET TISSUE DISPENSER UNLESS OTHERWISE NOTED VERTICAL VALVE CABINET VINYL COMPOSITION TILE VINYL WALL COVERING WELDED WIRE FABRIC

LIST OF DRAWINGS

<u> ARCHITECTURAL DRAWINGS — SNS ARCHITECTS & ENGINEERS, PC</u> COVER SHEET, GENERAL NOTES BUILDING DEPARTMENT NOTES, EGRESS PLANS & PARTIAL

DEMOLITION PLANS FIRST & SECOND FLOOR PLANS, DOOR SCHEDULE & DETAILS ENLARGED PLANS, NOTES, LEGEND, & PARTITION TYPES ENLARGED PLAN, MILLWORK, DETAILS & EQUIPMENT SCHEDULE STAIR PLAN & DETAILS & FINISH SCHEDULE MECHANICAL DRAWINGS - LINWOOD ENGINEERING ASSOCIATES, P.A. HVAC NOTES, DETAILS & SYMBOLS

FIRST & SECOND FLOOR HVAC PLANS


ENLARGED FIRST & SECOND FLOOR HVAC PLANS <u>ELECTRICAL DRAWINGS - LINWOOD ENGINEERING ASSOCIATES, P.A.</u> ELECTRIC NOTES, SPECIFICATIONS & SYMBOLS FIRST & SECOND FLOOR ELECTRICAL DEMOLITION PLANS CRAWL SPACE, FIRST FLOOR & SECOND FLOOR ELECTRICAL PLANS ENLARGED FIRST & SECOND FLOOR ELECTRICAL PLANS CRAWL SPACE, FIRST FLOOR, SECOND FLOOR & ATTIC FIRE ALARM PLANS FIRE ALARM NOTES, RISER DIAGRAM, SCHEDULE & SYSTEM SEQUENCE OF OPERATION MATRIX

LIGHTING FIXTURE SCHEDULE, PANEL SCHEDULES & DETAILS PLUMBING DRAWINGS - LINWOOD ENGINEERING ASSOCIATES, P.A. PLUMBING NOTES, SYMBOLS & SCHEDULES CRAWL SPACE, FIRST & SECOND FLOOR PLUMBING PLANS ENLARGED FIRST & SECOND FLOOR PLUMBING PLANS

PLUMBING RISER DIAGRAMS & DETAILS

FIRE PROTECTION DRAWINGS - LINWOOD ENGINEERING ASSOCIATES, P.A. FIRE PROTECTION NOTES & SYMBOLS CRAWL SPACE, FIRST & SECOND FLOOR FIRE PROTECTION PLANS ATTIC FIRE PROTECTION PLAN & DETAILS ENLARGED FIRST & SECOND FLOOR FIRE PROTECTION PLANS

	10040	2 00011p41011
03-06-15	1	ISSUED FOR DCA FILING
03-18-15	2	ISSUED FOR BIDDING
03-27-15	3	ISSUED FOR DCA FILING & CONSTRUCTION
04-07-15	4	ISSUED PER ADDENDUM 1

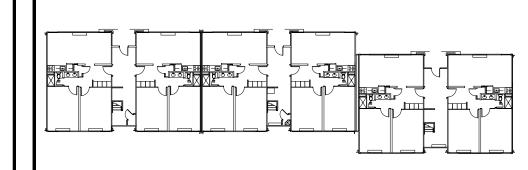

Consultants




LINWOOD ENGINEERING ASSOCIATES, P.A. **CONSULTING ENGINEERS** 955 Lincoln Avenue

Glen Rock, New Jersey 07452 TELEPHONE (201) 857-3998 FAX: (201) 857-3994

INTERIOR RENOVATIONS MIMOSA - G RESIDENCE



DCA PROJECT# 9071-15

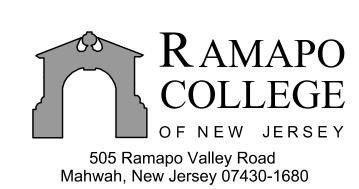

Architects & Engineers, PC

1 PARAGON DRIVE . MONTVALE . NEW JERSEY. 07645 TEL: 201.573.1767 FAX: 201.573.0808

Fay W. Logan, AIA John M. Lignos, AIA

Lorin J. Sonenshine, AIA Steven Napolitano, PE

Cert./Lic. No. Al 109740 01-12-15 Drawn By DP


Dwg. Title **COVER SHEET**

GENERAL NOTÉS Work Order No.

Scale NONE

Checked By DP

www.sns-arch-eng.com

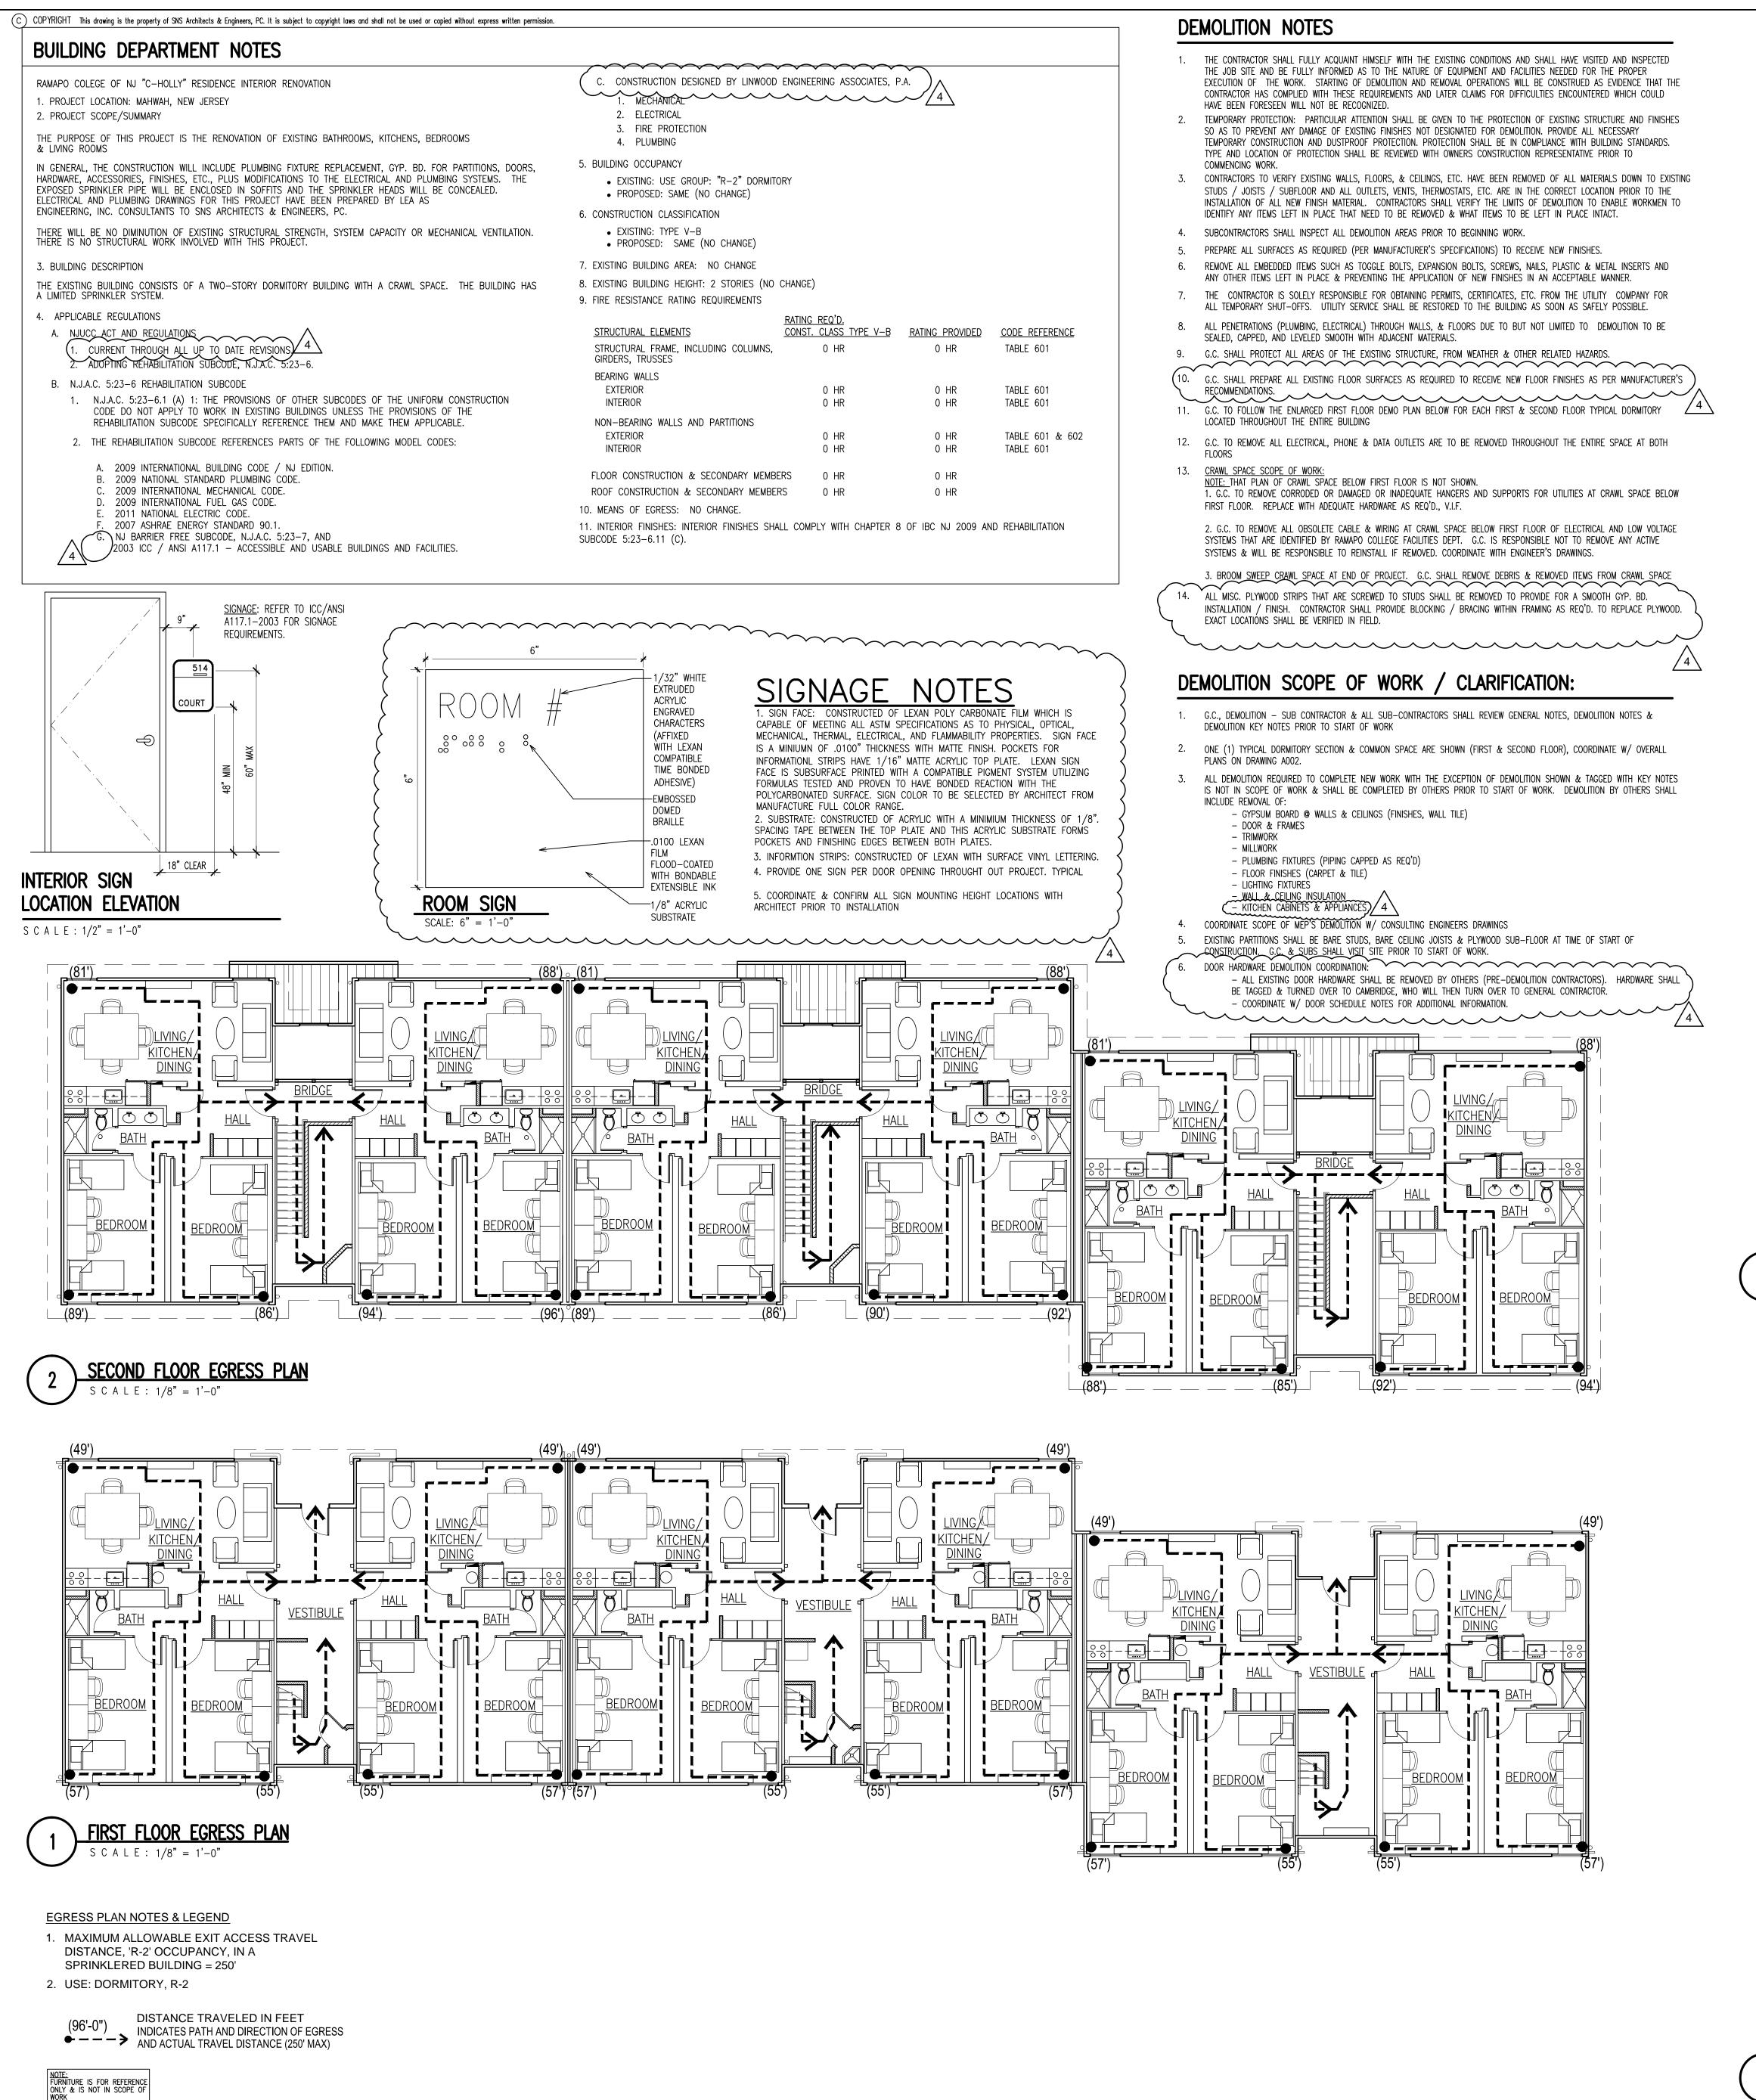


DEMOLITION KEY NOTES

- (1) REMOVE EXISTING STAIRCASE FROM FIRST TO SECOND FLOOR
- REMOVE EXISTING STAIRCASE FROM FIRST TO SECOND FLOOR


 REMOVE EXISTING RAILING AT BRIDGE, GONTRACTOR SHALL PROVIDE TEMPORARY
- PROTECTION AS REQ'D. DURING CONSTRUCTION
- REMOVE EXISTING WOOD FRAME PARTITION FROM FLOOR TO CEILING AS INDICATED
- REMOVE SECTION OF EXISTING WOOD FRAME PARTITION FROM FLOOR TO CEILING.
 RELOCATE EXISTING PIPING LOCATED IN SECTION OF WALL THAT IS BEING REMOVED.

 REMOVE EXISTING FIRE SPRINKLER PIPING AT VESTIBULE. SEE ENGINEERS FIRE
- PROTECTION PLAN FOR SCOPE OF DEMOLITION & NEW WORK
- (6) EXISTING SPRINKLER MAIN TO REMAIN, COORDINATE EXTENT OF WORK W/ ENGINEERING DRAWINGS
- REMOVE EXISTING WATER HEATER, COORDINATE W/ PLUMBING DRAWINGS
- 8 EXISTING RECESSED ELECTRICAL PANEL TO REMAIN, COORDINATE W/ ELECTRICAL
- PPROXIMATE LOCATION OF EXISTING FAN COIL UNIT REMOVED BY OTHERS. EXISTING
- SUPPLY LINES BELOW TO REMAIN, COORDINATE W/ ENGINEER DRAWINGS

 (10) EXISTING EXTERIOR DOOR & FRAME TO BE REMOVED. THE EXISTING DOOR LOCKS ARE
- TO BE REMOVED & RE-USED WITH THE NEW DOORS, COORDINATE W/ CONSTRUCTION MANAGER & SECURITY CONSULTANT
- (11) EXISTING WINDOWS TO REMAIN
- (12) EXISTING ACCESS HATCH TO CRAWL SPACE TO REMAIN

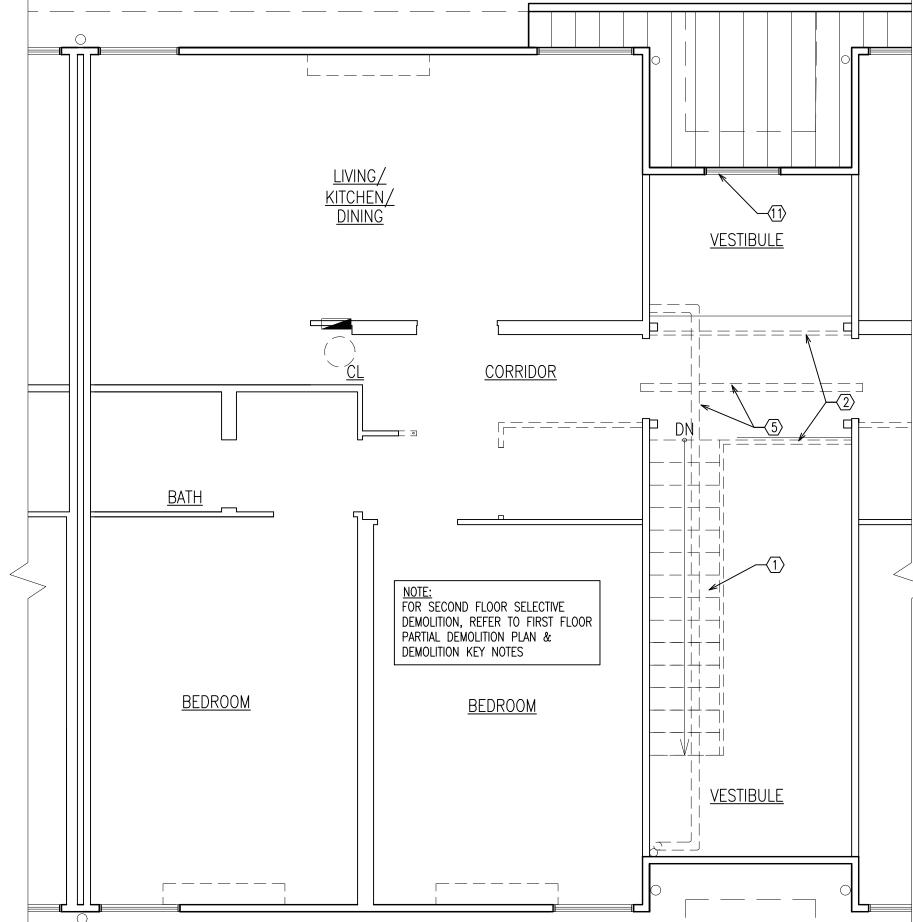


4 ENLARGED SECOND FLOOR PARTIAL DEMO PLAN

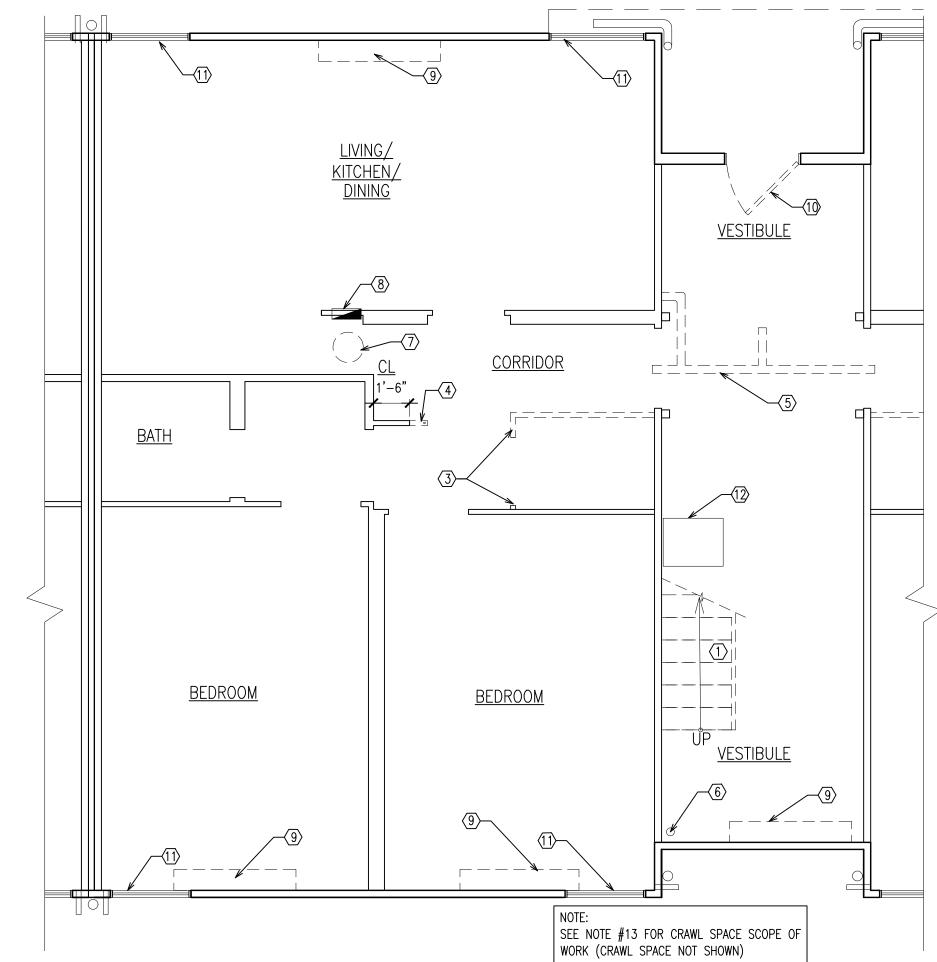

S C A L E: 1/4" = 1'-0"

DateIssueDescription03-06-151ISSUED FOR DCA FILING03-18-152ISSUED FOR BIDDING03-27-153ISSUED FOR DCA FILING & CONSTRUCTION04-07-154ISSUED PER ADDENDUM 1

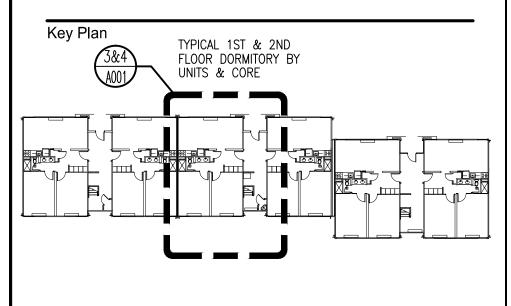

TYPICAL FLOOR

Consultants

Revisions



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CONSULTING ENGINEERS

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Proje

INTERIOR RENOVATIONS AT THE


MIMOSA - G RESIDENCE




Mahwah, New Jersey 07430-1680

DCA PROJECT# 9071-15

RAMAPO

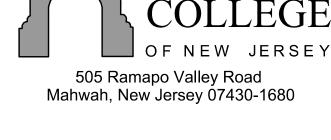

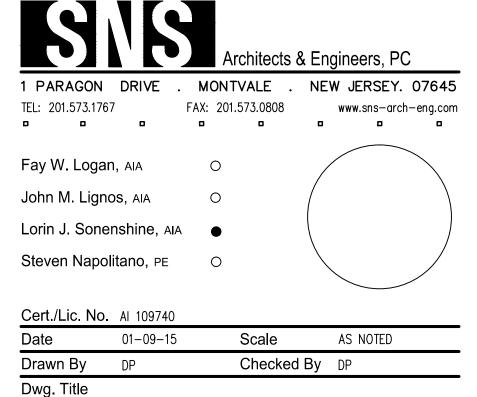


BUILDING DEPARTMENT NOTES EGRESS
PLANS & PARTIAL DEMOLITON PLANS

Work Order No.

Dw

Dwg. No.

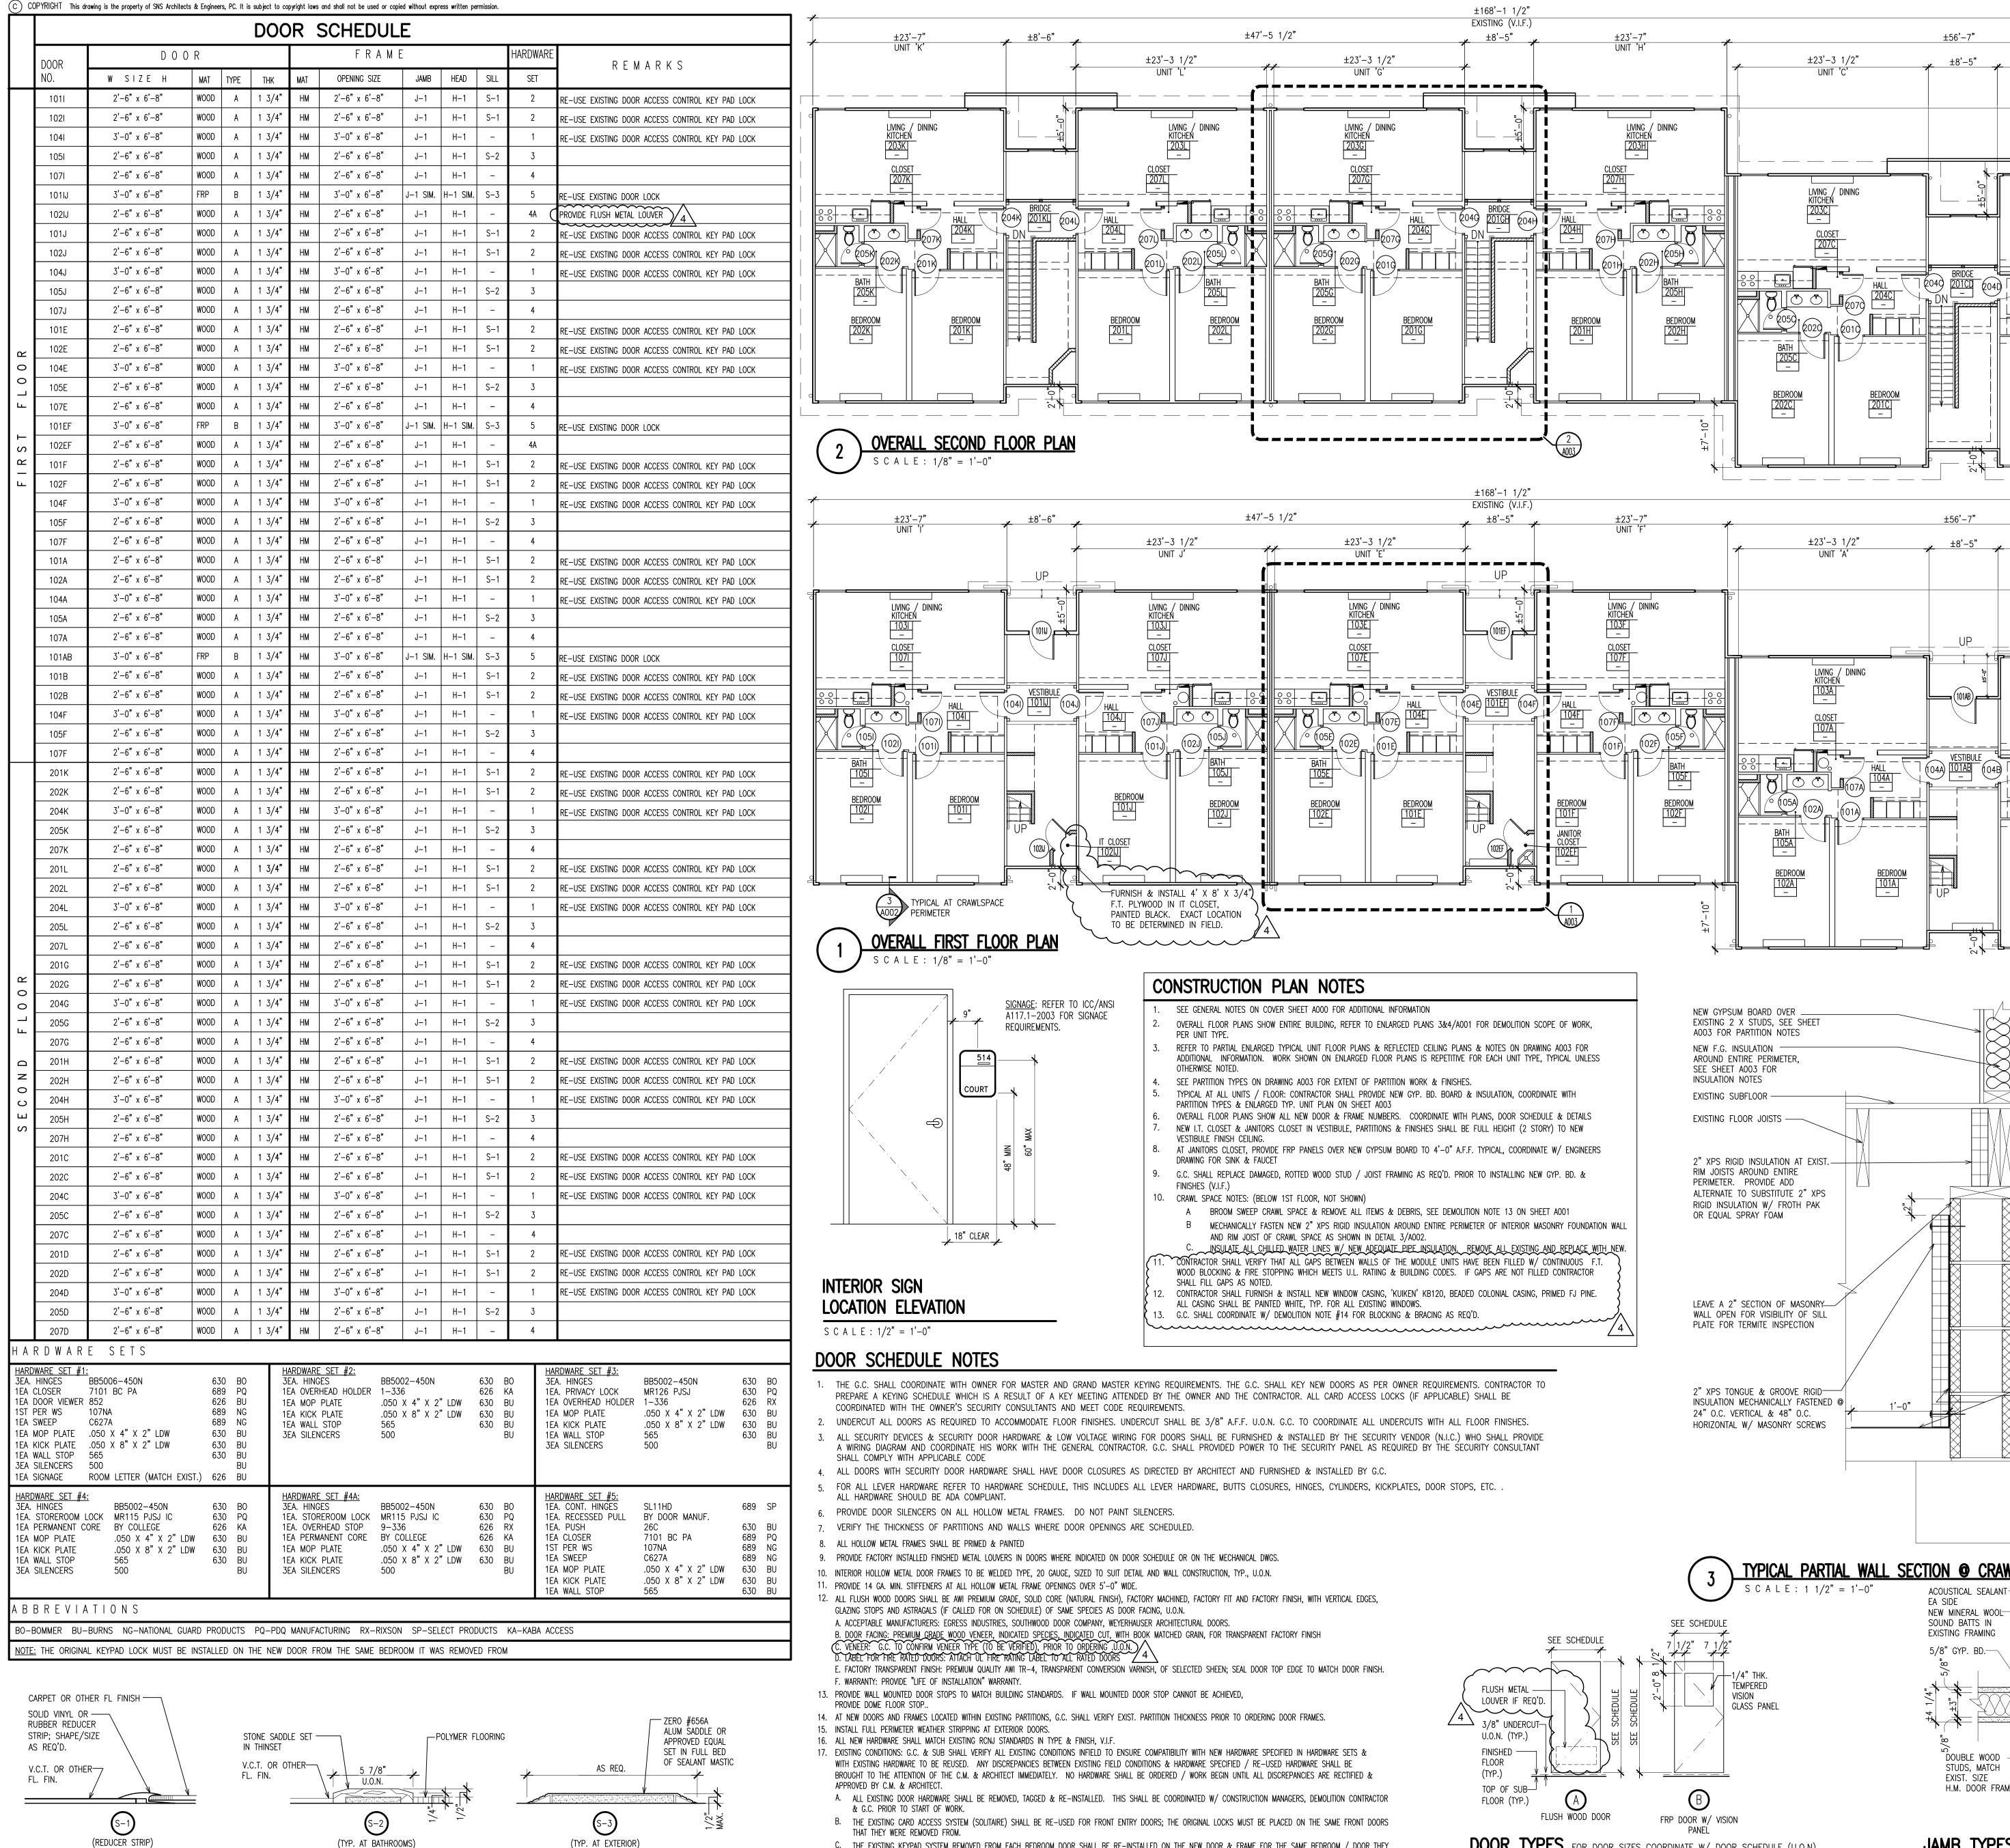

C. THE EXISTING KEYPAD SYSTEM REMOVED FROM EACH BEDROOM DOOR SHALL BE RE-INSTALLED ON THE NEW DOOR & FRAME FOR THE SAME BEDROOM / DOOR THEY

D. IN THE EVENT THAT EXISTING HARDWARE TO BE RE-USED IS DAMAGED & / OR MISSING, CONTRACTOR SHALL NOTIFY C.M. PRIOR TO PROCEEDING W/ ANY WORK.

18. ALL LOCKSETS SHALL BE FURNISHED W/ CONSTRUCTION CORES.

SCALE: NOT TO SCALE



----+

BATH 105B

G.C. MAY SUBMIT ALTERNATE COST TO

SUBSTITUTE ALL 2" RIGID INSULATION

INSTALLED FROM SLAB TO UNDERSIDE

PERIMETER OF CRAWL SPACE W/O THE

EQUIVALENT FLAME SPREAD RATING AS

G.C TO VERIFY THAT THE

GRADE IS PITCHED AWAY

NOTIFY ARCHITECT & CM

IF GRADE PITCHES TOWARD

CONTINUOUS TYPE 1 6MIL

POLY LINER VAPOR BARRIER ADHERED TO MASONRY WALL

WITH WATER-BASED ADHESIVE

EXTENDED 1'-0" OUT ONTO

MASTIC CONTINUOUS BEAD

FROM TOP TO BOTTOM OF

SLAB. TAPE ALL JOINTS

FOUNDATION WALL AND

FROM THE BUILDING.

THE BUILDING

OF DECK THROUGHOUT THE ENTIRE

VAPOR BARRIER AND HAVE AN

THE XPS RIGID INSULATION

THICK. FOAM INSULATION TO BE

W/ SPRAY APPLIED FOAM INSULATION

Description ISSUED FOR DCA FILING ISSUED FOR BIDDING ISSUED FOR DCA FILING & CONSTRUCTION ISSUED PER ADDENDUM



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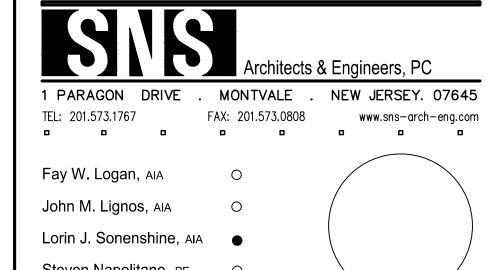
INTERIOR RENOVATIONS

AT THE MIMOSA - G RESIDENCE



DCA PROJECT# 9071-15







Scale AS NOTED Checked By MV

FIRST & SECOND FLOOR PLANS, Dwg. No.

DOUBLE WOOD STUDS, MATCH EXIST. SIZE H.M. DOOR FRAME-HEAD SIM. **DOOR TYPES** FOR DOOR SIZES COORDINATE W/ DOOR SCHEDULE (U.O.N)

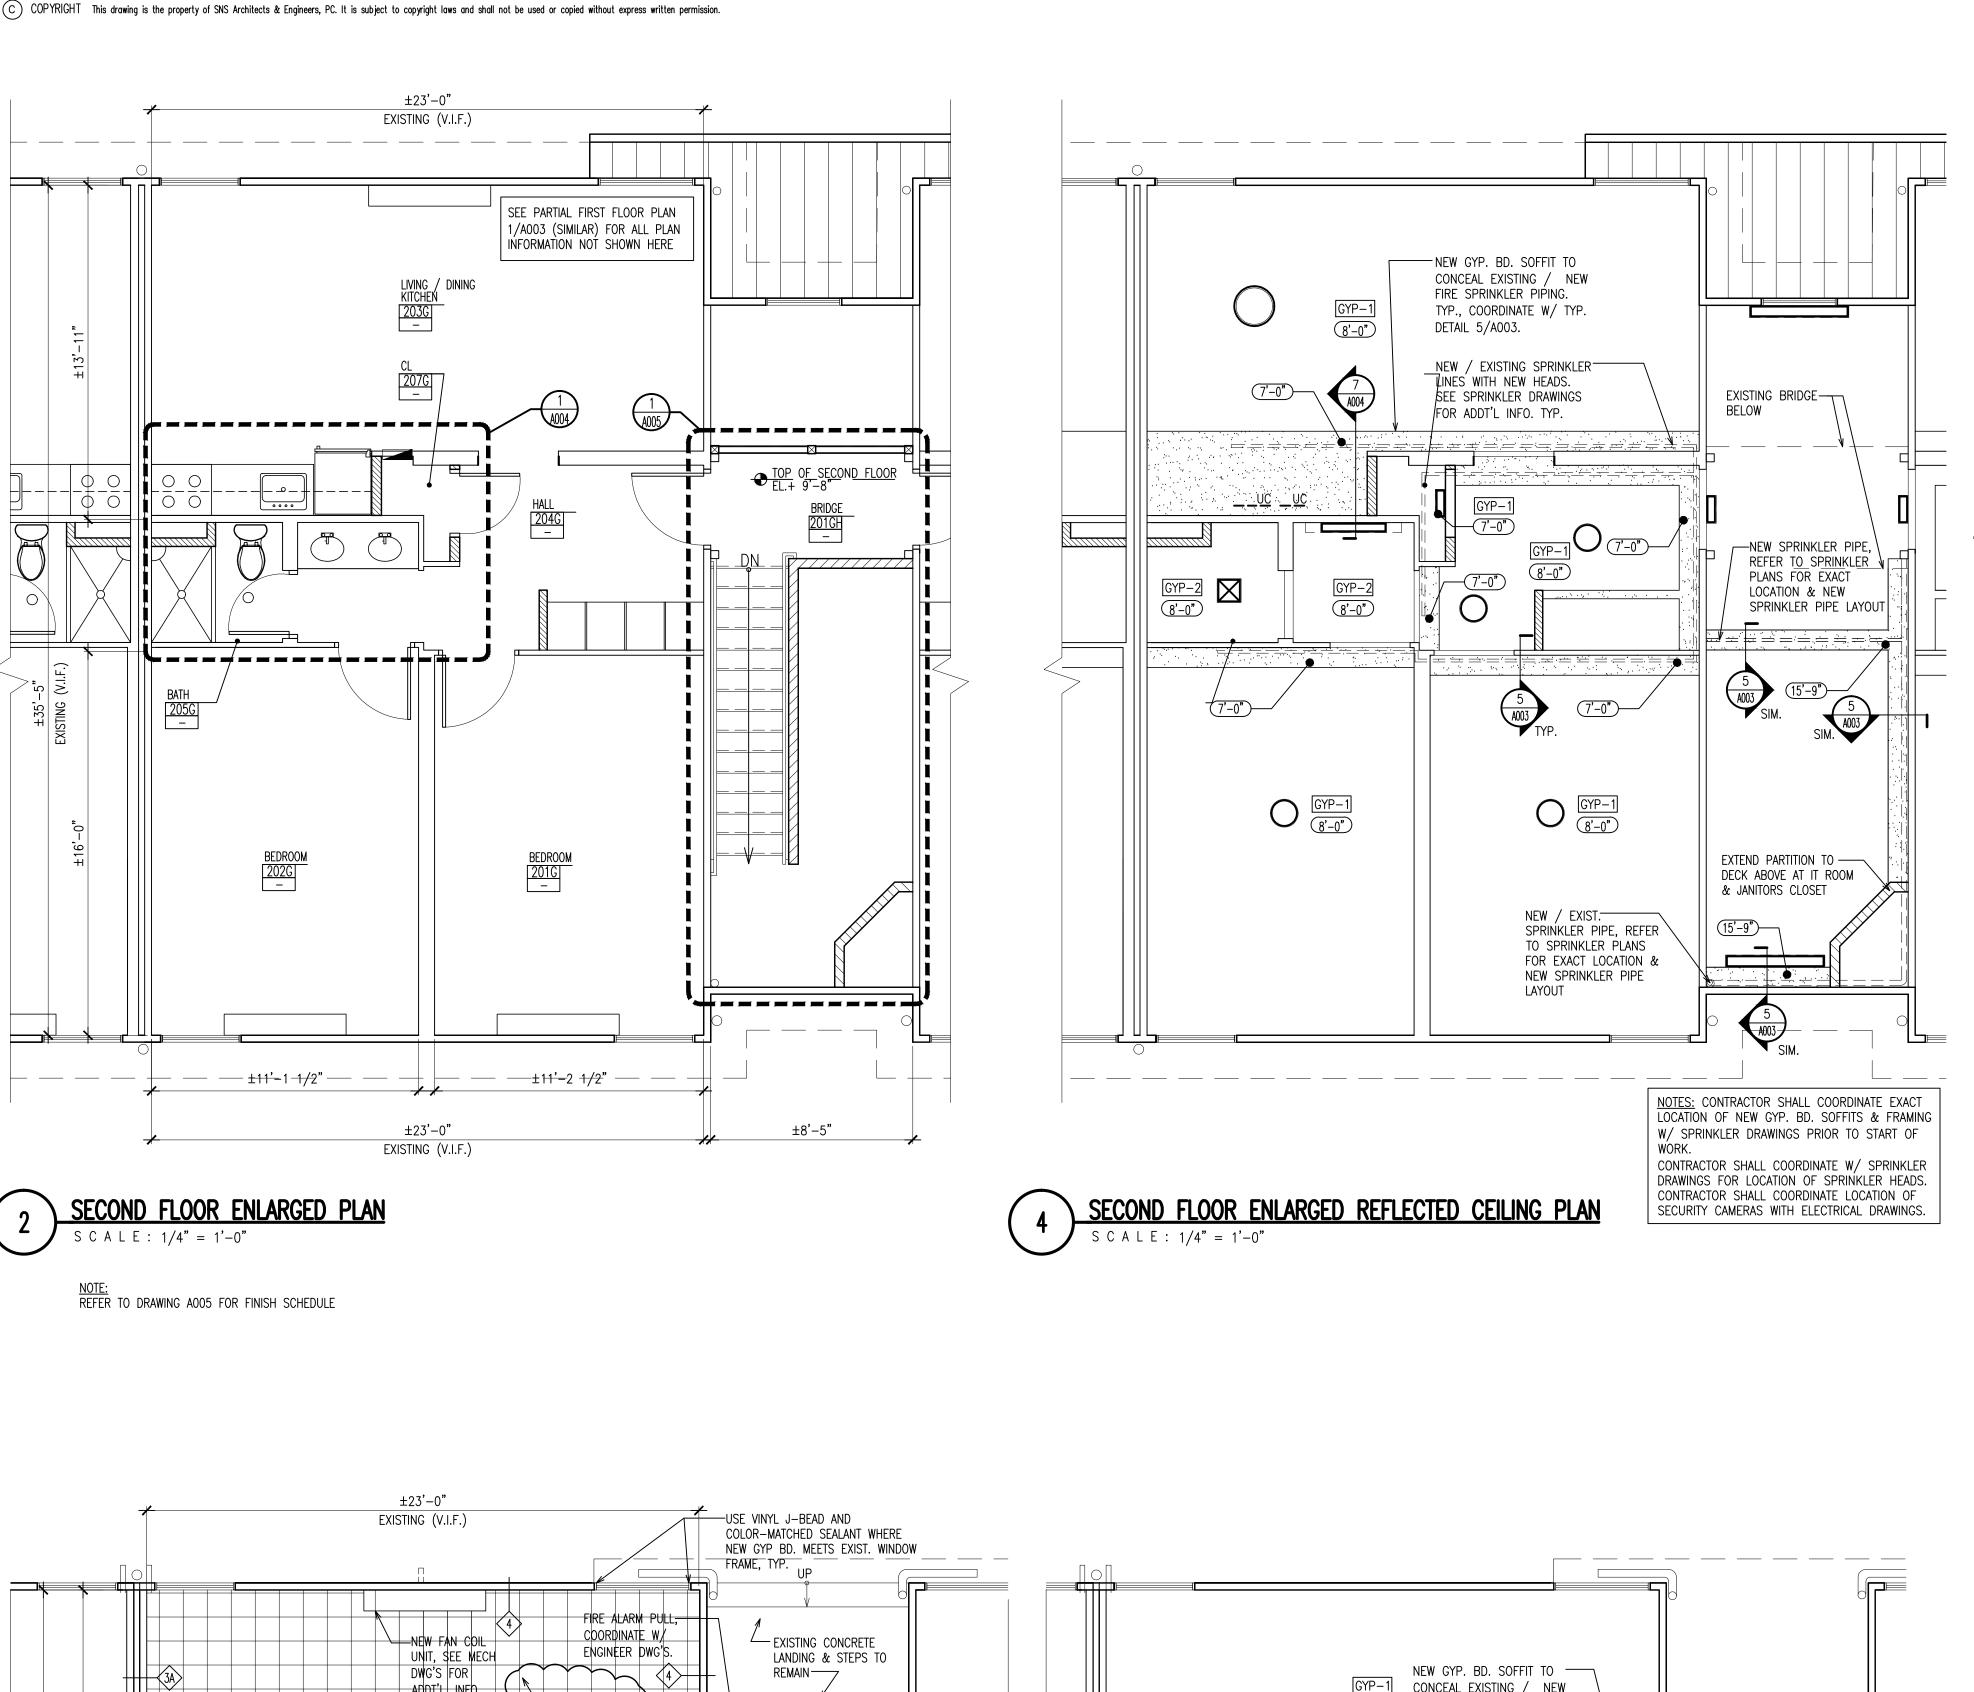

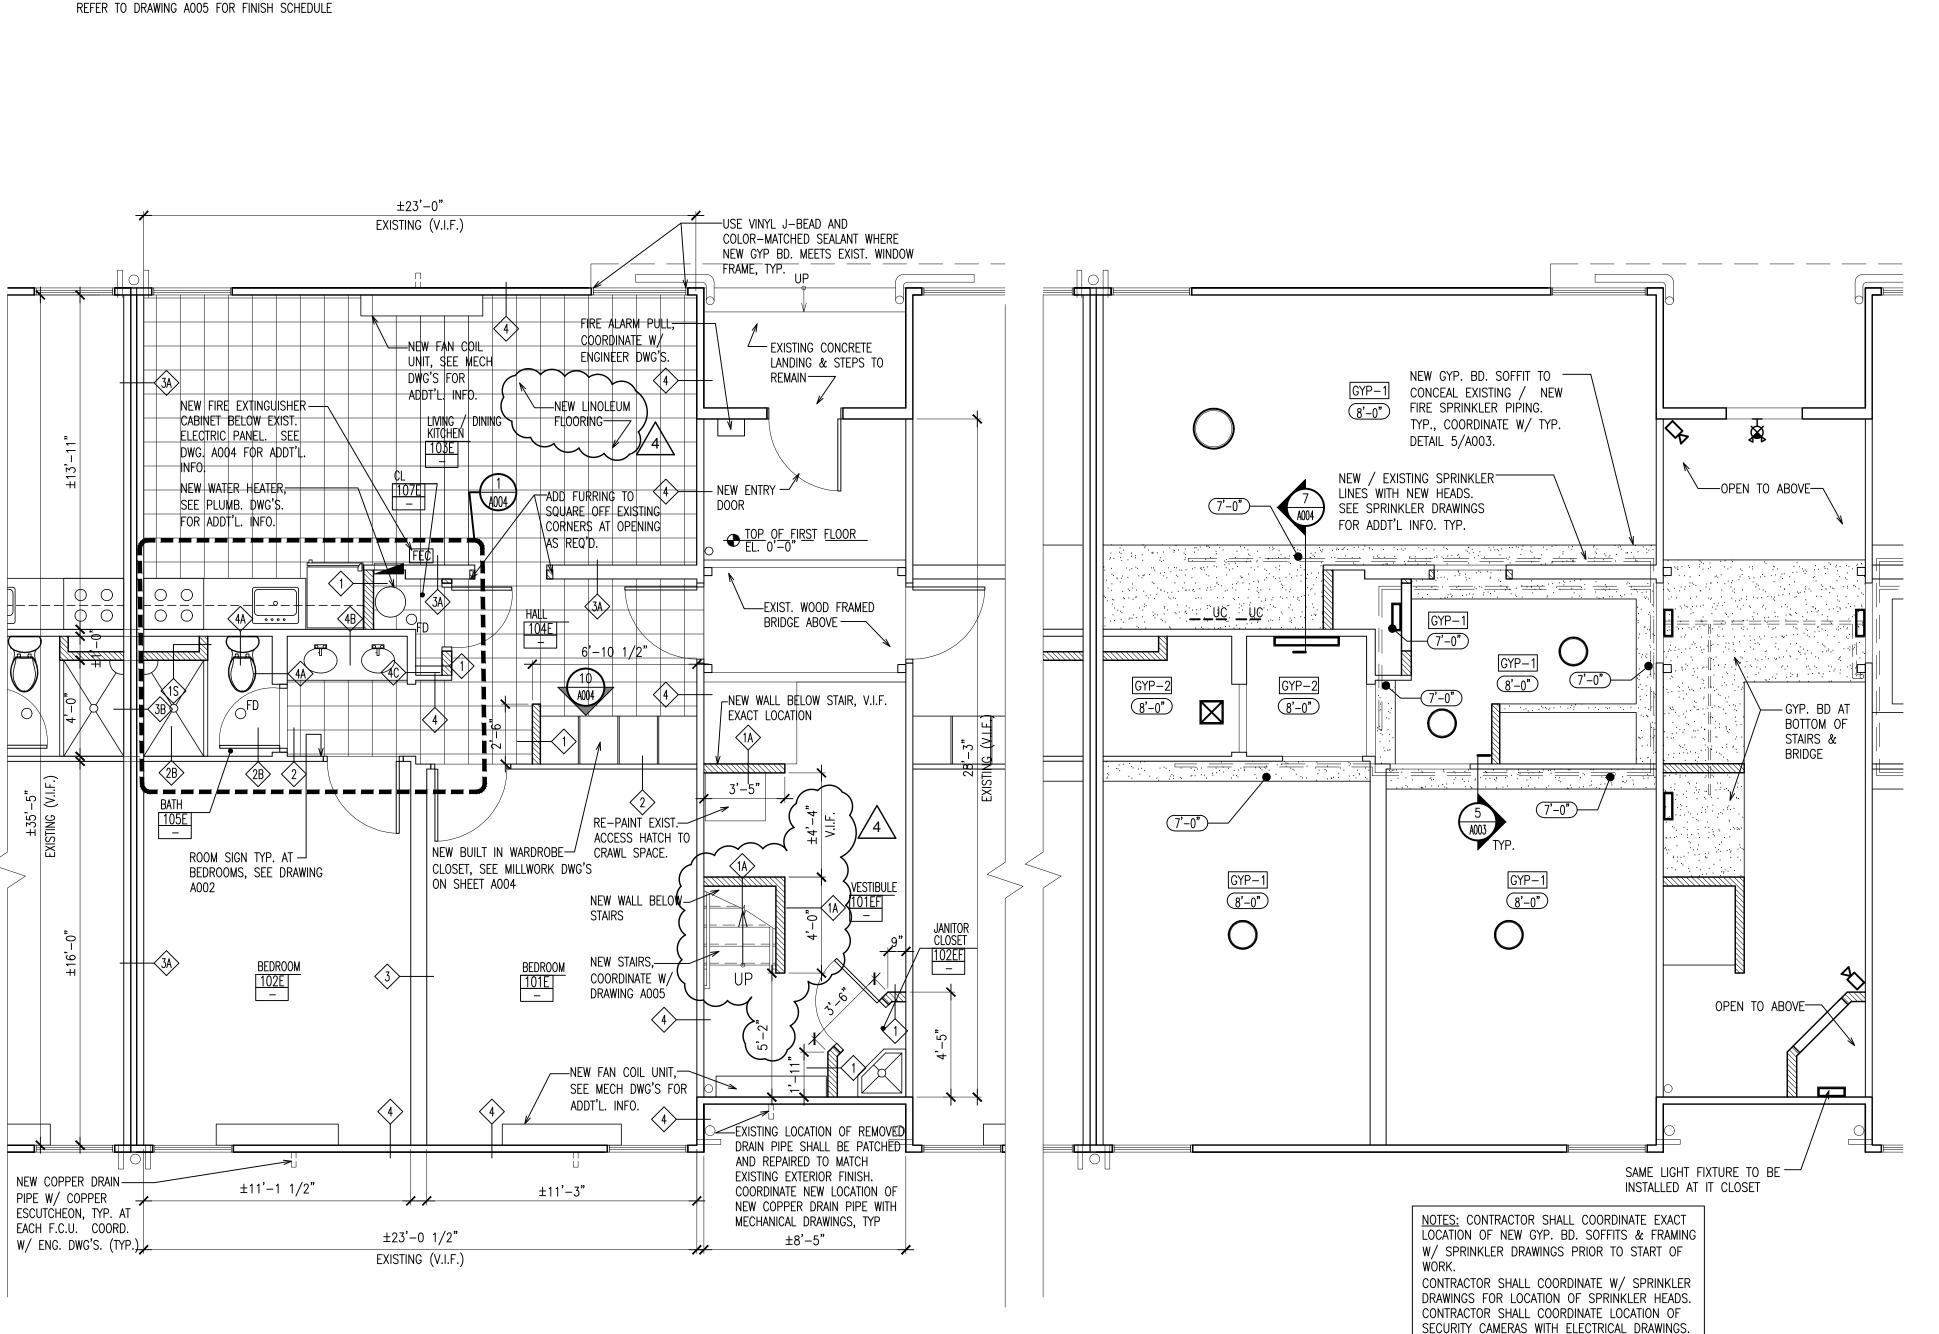


FIRST FLOOR ENLARGED REFLECTED CEILING PLAN

FIRST FLOOR ENLARGED PLAN

NOIE: REFER TO DRAWING A005 FOR FINISH SCHEDULE

S C A L E : 1/4" = 1'-0"

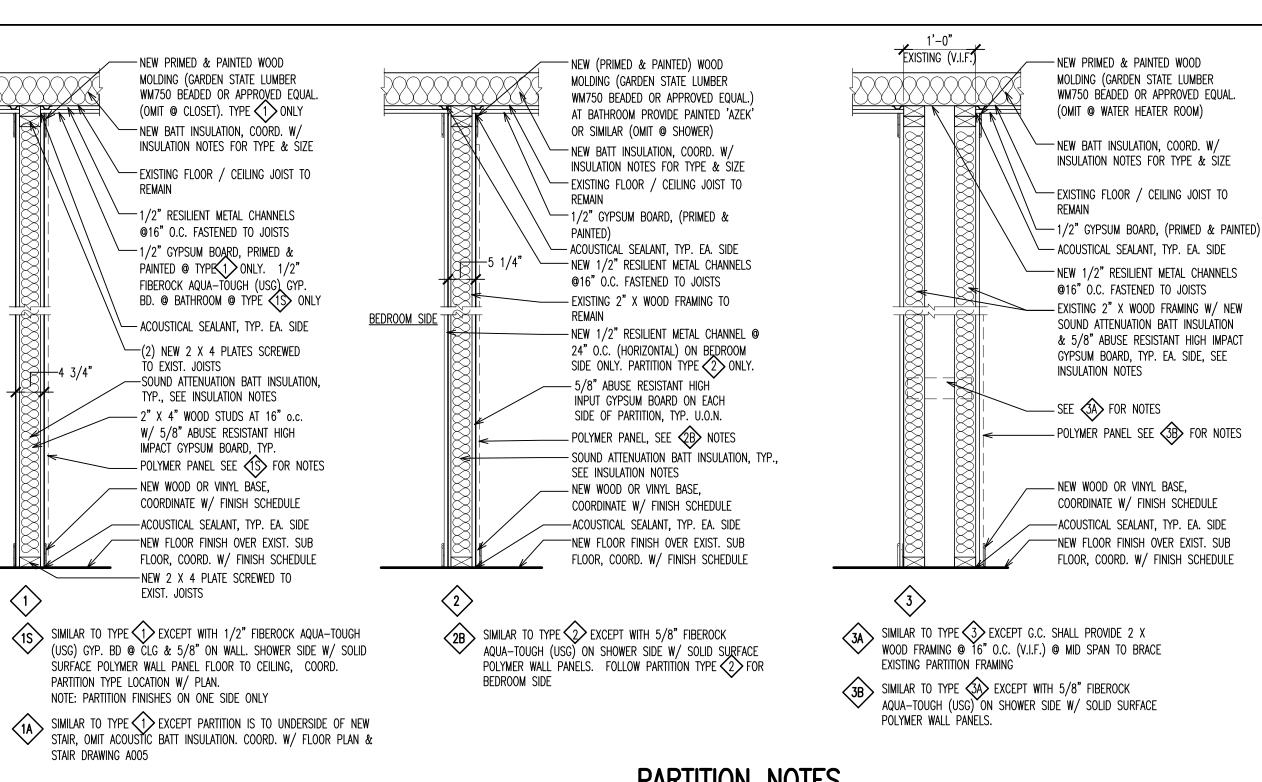

PARTITION NOTES

- 1. REFER TO PLAN FOR ALL NEW PARTITION TYPE LOCATIONS.
- 2. TAPE & SPACKLE ALL JOINTS IN DRYWALL, INCLUDING ALL DRYWALL ABOVE THE CEILING.
- 3. AT PARTITIONS THAT REQUIRE SOUND ATTENUATION BLANKETS, CONTRACTOR SHALL CAULK PERIMETER W/ SEALANT & SEAL ALL PENETRATIONS INCLUDING PIPING, DUCT WORK, ELECTRICAL BOXES, ETC.
- 4. BRACE ALL WOOD STUD PARTITIONS AT ALL LOCK SIDES OF DOORS, WHERE DUCTS INTERFERE W/ METAL STUDS GOING TO UNDERSIDE OF CONCRETE SLAB, JOISTS, AND WHERE CALLED FOR ON DRAWINGS.
- 5. ALL PARTITIONS SUPPORTING MILLWORK CABINETS AND/OR SHELVING SHALL HAVE WOOD STUDS SPACED @ 12" O.C. IN LIEU OF 16" O.C., AT EXISTING PARTITION WALLS ADD ADDITIONAL STUDS AS REQUIRED. 6. PROVIDE CONTROL JOINTS IN GYP. BD. PARTITIONS OVER 30 FT IN LENGTH AND AT ALL INTERSECTIONS OF COLUMN'S & WHERE RECOMMENDED BY
- MANUFACTURER'S PRINTED STANDARDS. 7. GENERAL CONTRACTOR SHALL PROVIDE FLUSH MOUNTED ACCESS DOOR
- WHERE REQUIRED BY MECHANICAL DRAWINGS. 8. GYPSUM BOARD NOTES:
- A) AT ALL BATHROOM WALLS; 5/8" FIBEROCK BRAND AQUA-TOUGH (USG). B) AT ALL OTHER INTERIOR PARTITIONS; 5/8" ABUSE RESISTANT HI-IMPACT GYPSUM BOARD FOR FIRST 8'-0". 5/8" TYPE 'X' GYPSUM BOARD ABOVE
- C) TAPE & SPACKLE ALL JOINTS READY TO RECEIVE NEW FINISHES 9. SEE INSULATION NOTES FOR WALLS, CEILING / FLOORS ON DRAWING A003 10. NEW WOOD BASE, FURNISHED & INSTALLED BY G.C. SHALL BE 'KUIKEN' KB205, COLONIAL BASE MOLDING PRIMED FJ PINE, PAINTED WHITE TYP.
- INSULATION NOTES: -G.C TO FURNISH & INSTALL R-19 F.G. INSULATION BETWEEN ALL EXIST. FLOOR / CLG JOISTS BETWEEN 1ST & 2ND FLOOR
- THROUGHOUT THE ENTIRE BUILDING.

 —IN ATTIC, G.C. TO FURNISH & INSTALL R—30 F.G. INSULATION OR 9" THICK BLOWN IN F.G. INSULATION. G.C. TO DETERMINE WHAT METHOD WILL BE USED -AT EXTERIOR WALL, DEMISING UNIT WALLS & DEMISING BEDROOM WALLS ON ALL FLOORS AROUND THE ENTIRE PERIMETER OF THE BUILDING, G.C. TO INSTALL R-13 F.G. INSULATION W/ PAPER ON THE WARM SIDE. -NOTE: CONTRACTOR SHALL INSTALL ARC WIRE BETWEEN INSULATION

& FRAMING SUPPORTS AT CEILING / FLOOR & ATTIC, TYP.

REFLECTED CEILING PLAN LEGEND

GYP. BOARD SOFFIT, COORD. W/ PLANS &

WALL MOUNTED LED LIGHT FIXTURE

14" Ø SURFACE MOUNTED LED LIGHT FIXTURE 22" Ø SURFACE MOUNTED LED LIGHT FIXTURE

SURFACE MOUNTED COMBO LED LIGHT FIXTURE / EXHAUST FAN

- NEW PRIMED & PAINTED WOOD MOLDING (GARDEN STATE LUMBER

WM750 BEADED OR APPROVED EQUAL. NEW BATT INSULATION, COORD. W/

PARTITION TYPE NOTES FOR TYPE &

- EXISTING FLOOR / CEILING JOIST TO

-1/2" GYPSUM BOARD, PRIMED &

— ACOUSTICAL SEALANT, TYP. EA. SIDE

@16" O.C. FASTENED TO JOISTS

-EXISTING 2" X WOOD FRAMED INTERIOR

PARTITION OR EXTERIOR PARTITION.

FOIL FACED BATT INSULATION @

EXTERIOR PARTITIONS & SOUND

ATTENUATION @ INTERIOR PARTITIONS. SEE INSULATION NOTES FOR ADDT'L.

-5/8" ABUSE RESISTANT HIGH IMPACT

GYP. BD. TYP. EACH SIDE OF INTERIOR

PARTITION & INTERIOR SIDE OF

COORDINATE W/ FINISH SCHEDULE

——ACOUSTICAL SEALANT, TYP. EA. SIDE

NEW FLOOR FINISH OVER EXIST. SUB

FLOOR, COORD. W/ FINISH SCHEDULE

EXTERIOR PARTITION

SIMILAR TO TYPE 4 EXCEPT WITH 5/8" FIBEROCK AQUA-TOUGH (USG) GYP. BD ON BOTH SIDES W/ POLYMER WALL PANELS

SIMILAR TO TYPE 4 EXCEPT WITH 5/8" FIBEROCK AQUA-TOUGH

SIMILAR TO TYPE 4B EXCEPT WITH 5/8" FIBEROCK AQUA-TOUGH

(USG) GYP. BD ON EACH SIDE. COORD. FINISH W/ PLANS &

(USG) GYP. BD ON SINK SIDE ONLY. COORD. FINISH W/ PLANS 8

BATHROOM SIDE ONLY, COORD. W/ PLANS

PARTITION TYPES

NEW WOOD OR VINYL BASE,

COORD. W/ PLANS

SURFACE MOUNTED LED LIGHT FIXTURE

UNDER CABINET LED LIGHT FIXTURE


CEILING HEIGHT INDICATOR

1/2" GYP. BD. FASTENED TO EXIST. WOOD CLG. / FLOOR JOISTS, COORD. W/ PARTITION TYPE

FIBEROCK AQUA-TOUGH (USG) 1/2" GYP. BD. FASTENED TO EXIST. WOOD CLG. / FLOOR JOISTS, COORD. W/ PARTITION

NEW WALL MOUNTED ILLUMINATED EXIT SIGN W/ EMERGENCY LIGHTING. ARROWS INDICATE PATH/ DIRECTION OF

INDOOR MINI-DOME CAMERA (SELECTED BY SECURITY CONSULTANT)

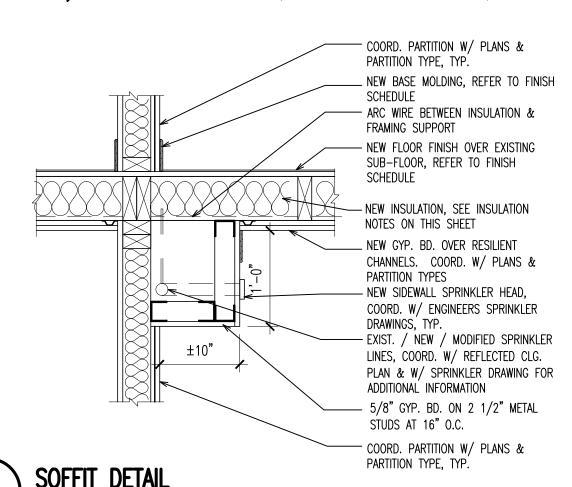


REFLECTED CEILING PLAN GENERAL NOTES

- 1. FOR ADDITIONAL GENERAL NOTES REFER TO DRAWING A000.
- 2. REFER TO CONSULTING ENGINEERS DRAWINGS FOR ALL ADDITIONAL EXIT LIGHTS, EMERGENCY LIGHTS AND NIGHT LIGHT LOCATIONS.
- 4. ALL GYPSUM BOARD CEILING SYSTEMS SHALL COMPLY WITH BUILDING CODE.
- 5. THE LOCATION OF ELECTRICAL EQUIPMENT. ETC. IS APPROXIMATE AND IS SUBJECT TO
- 6. ELECTRICAL CONTRACTOR SHALL PROVIDE ALL TEMPORARY LIGHT AND POWER AS
- 8. FOR LIGHT FIXTURE SPECS REFER TO ELECTRICAL DRAWINGS
- 9. TYPICAL CEILING FLATNESS TOLERANCE: 2" VARIANCE PER ROOM. PROVIDE SHIMS AS REQ'D. BELOW RESILIENT METAL CHANNELS FASTENED TO WOOD FRAMING OF FIRST FLOOR CEILING AND AT WOOD FRAMING OF SECOND FLOOR CEILINGS SUCH THAT CEILING HORIZONTAL ELEVATION AND FLATNESS DOES NOT VARY MORE THAN 2" PER ROOM FROM HIGH TO LOW POINTS OF CEILING GYPSUM WALL BOARD.
- 10. LOCATION OF EXISTING / NEW & MODIFIED SPRINKLER LINES & HEADS & SIDE WALL HEADS SHALL BE COORDINATED W/ SPRINKLER DRAWINGS PRIOR TO START OF WORK 11. SEE INSULATION NOTES FOR WALLS, CEILINGS / FLOORS ON DRAWING A003.

3. ALL CONTRACTORS ARE TO FOLLOW LAYOUT ON ARCHITECTURAL DRAWINGS AND COORDINATE WITH OTHER TRADES.

MODIFICATION IN FIELD IF REQUIRED AND APPROVED BY ARCHITECT.

7. COORDINATE REFLECTED CEILING PLAN WITH ELECTRICAL DRAWINGS.

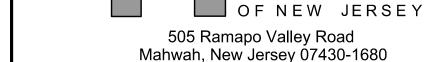

Revisions

03-18-15

03-27-15

04-07-15

TYPICAL FLOOR

Consultants

Issue

Description

ISSUED FOR DCA FILING

ISSUED PER ADDENDUM

ISSUED FOR DCA FILING & CONSTRUCTION

LINWOOD ENGINEERING

ASSOCIATES, P.A.

CONSULTING ENGINEERS

Glen Rock, New Jersey 07452

TELEPHONE (201) 857-3998

INTERIOR RENOVATIONS

AT THE

MIMOSA - G RESIDENCE


955 Lincoln Avenue

FAX: (201) 857-3994

ISSUED FOR BIDDING

DCA PROJECT# 9071-15



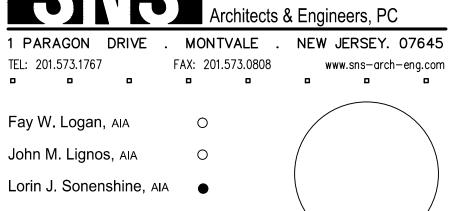



Lorin J. Sonenshine, AIA Steven Napolitano, PE O


Cert./Lic. No. Al 109740 Scale as noted 01-09-15 Checked By DP Drawn By DP

ENLARGED PLANS, NOTES,

Work Order No.

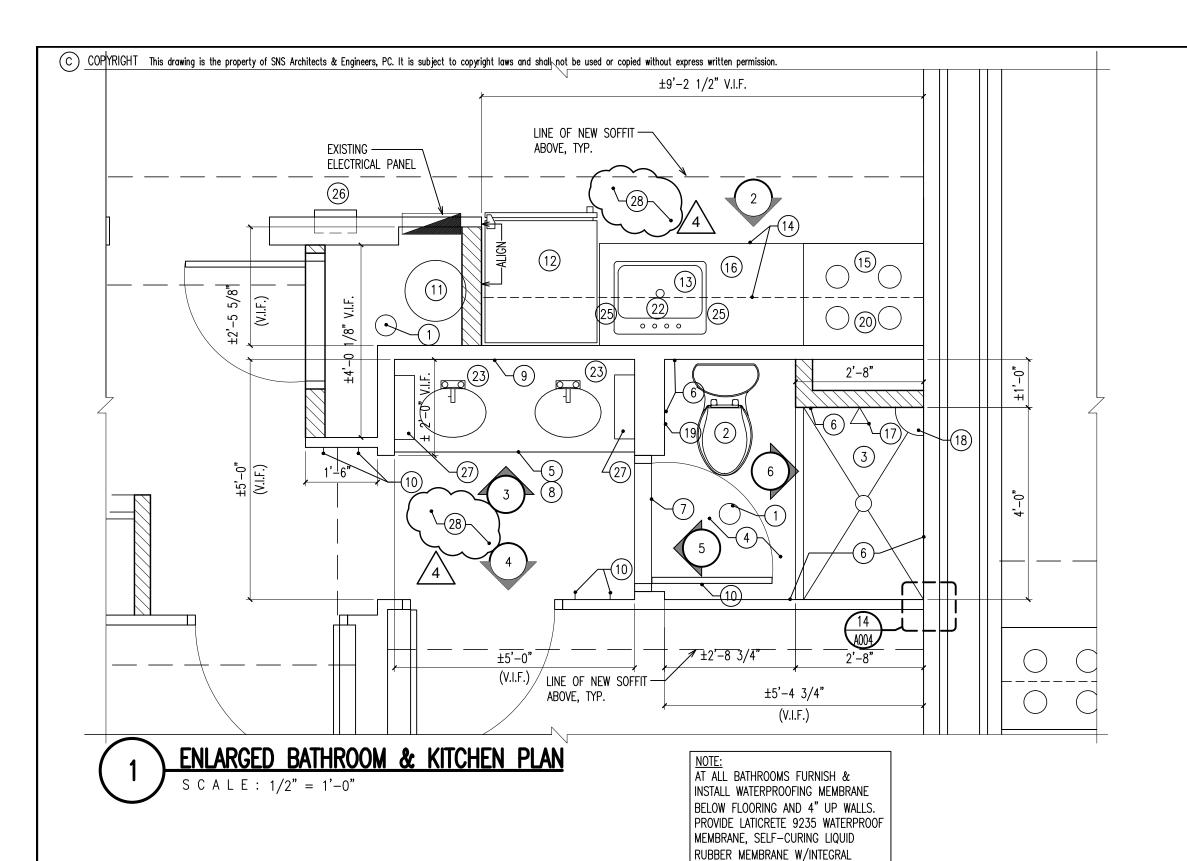


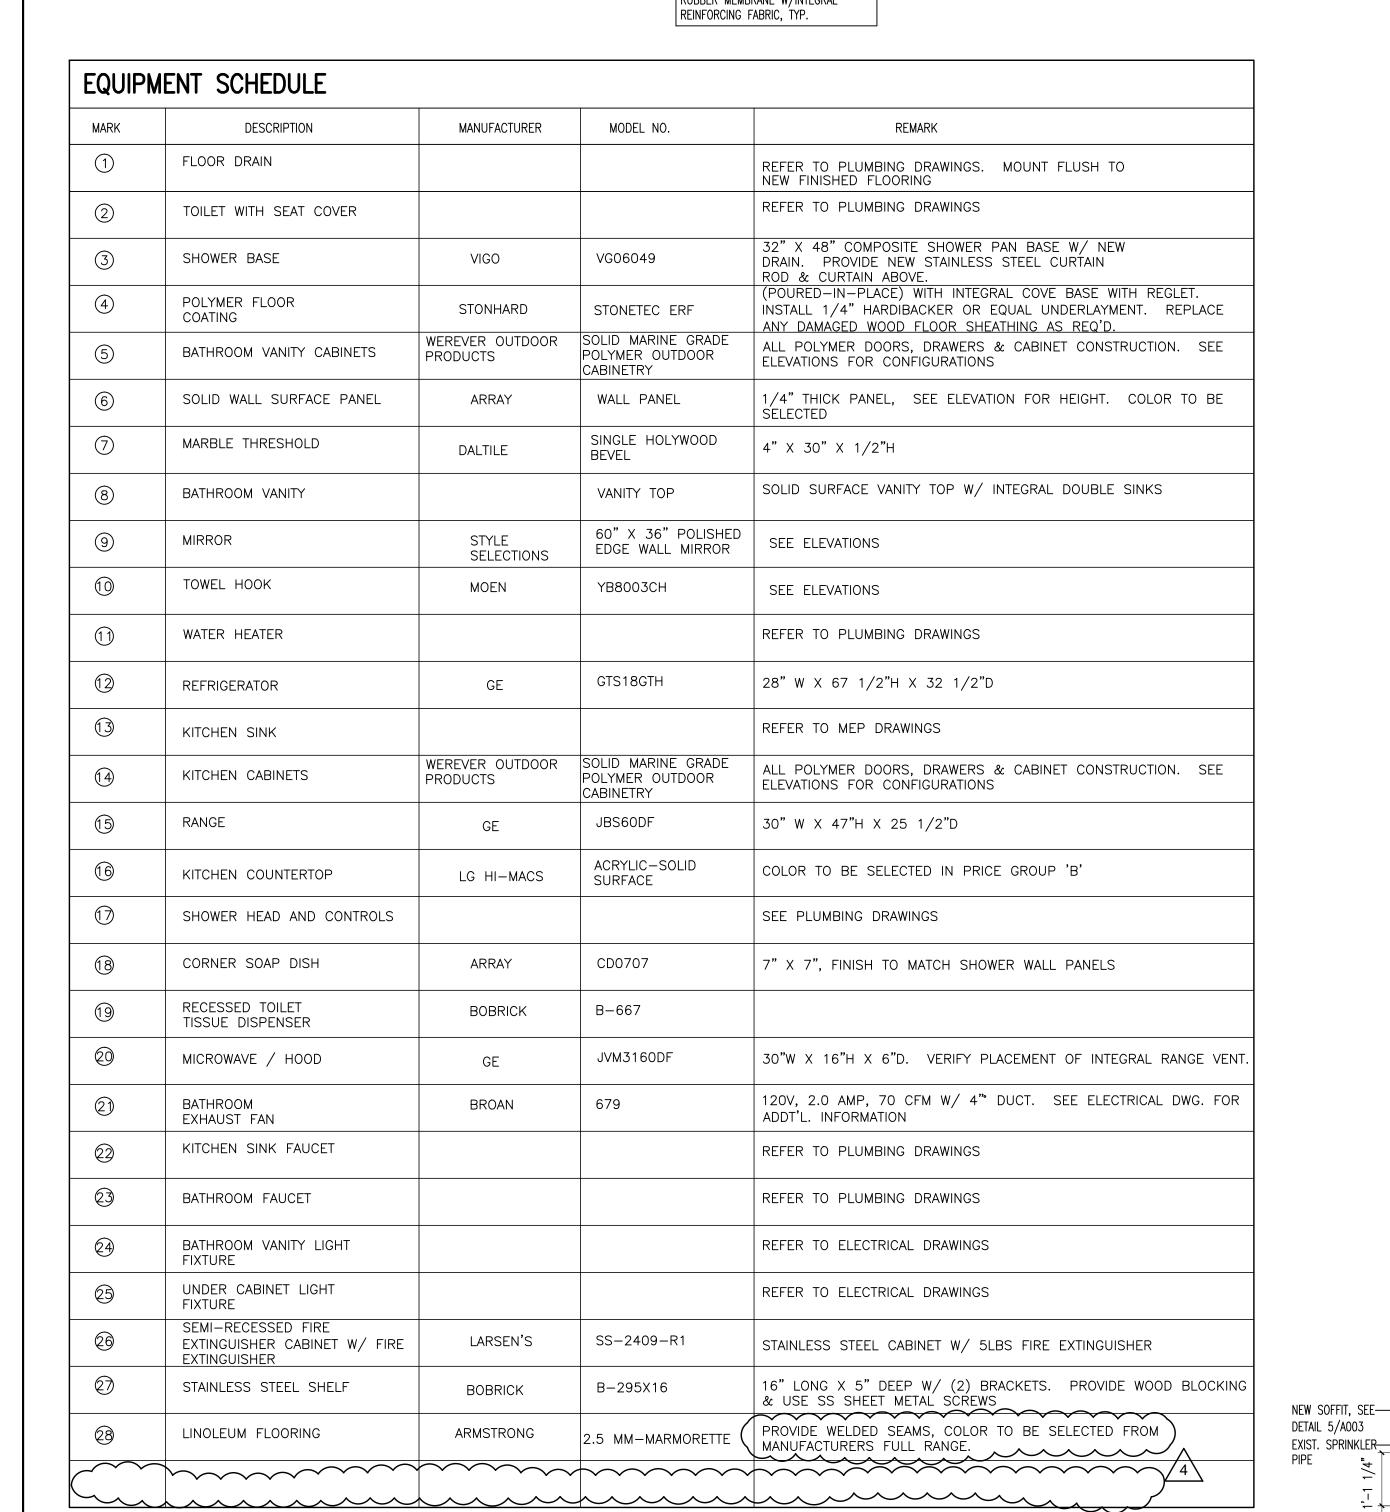

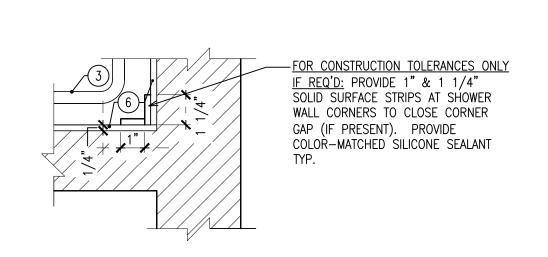



PLAN DETAIL AT SOLID SURFACE CORNER CONDITION


S C A L E : 3" = 1'-0"

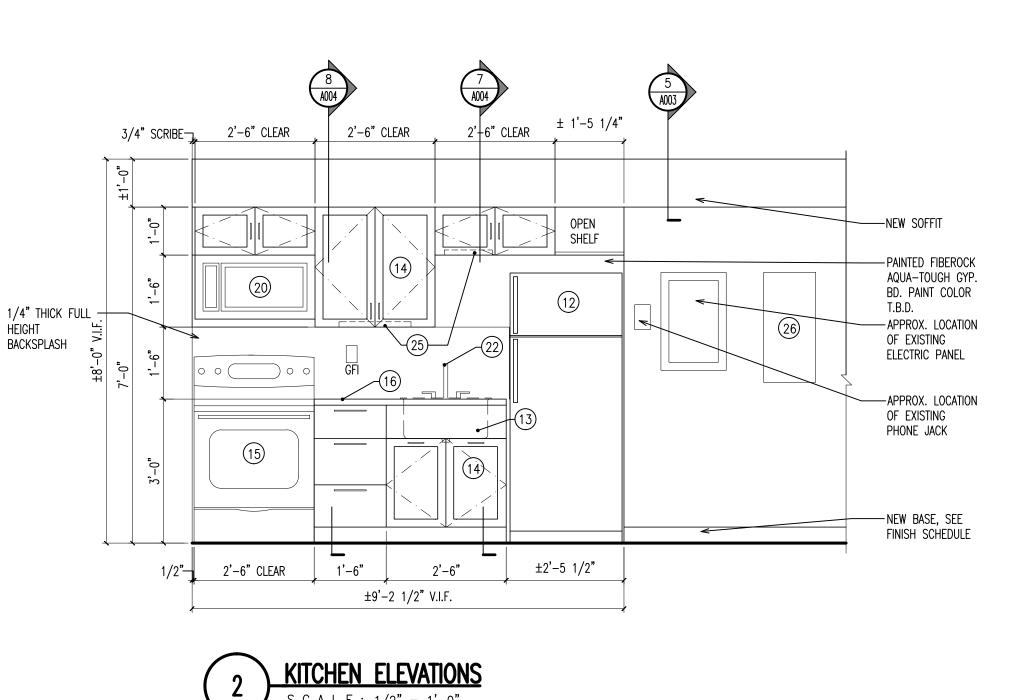




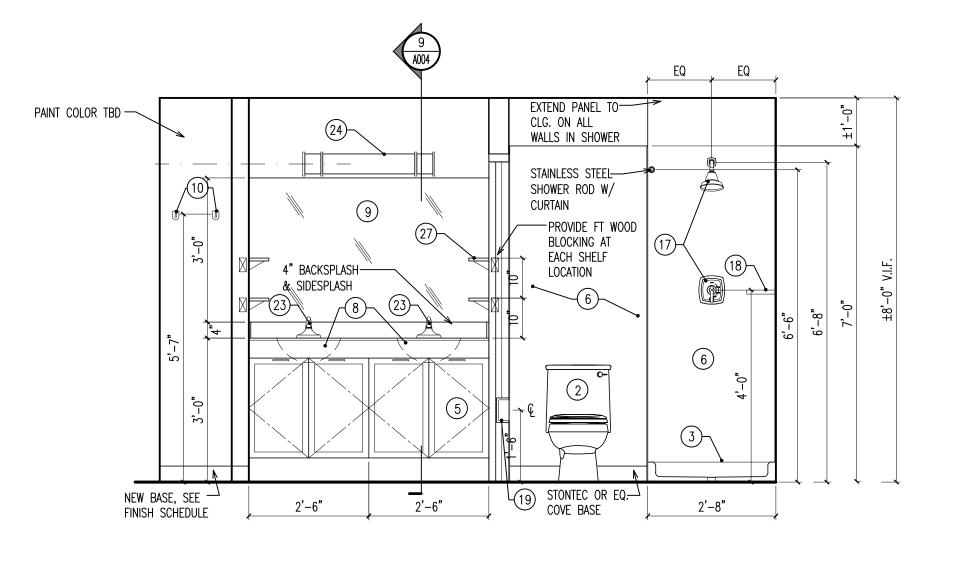

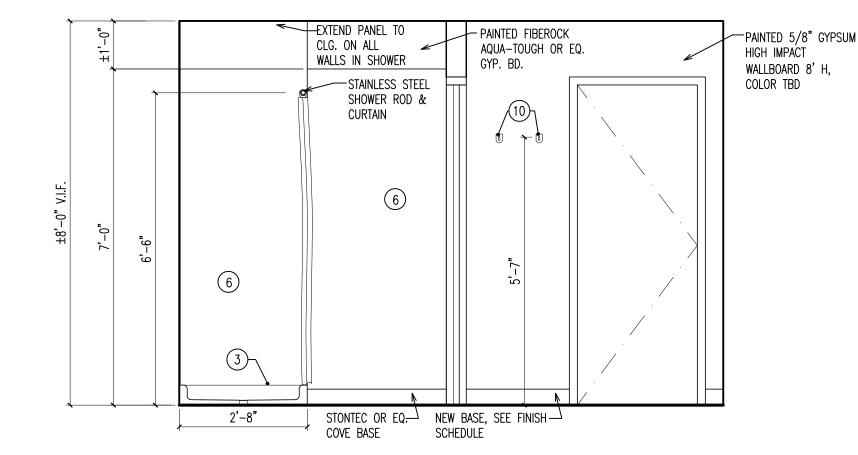

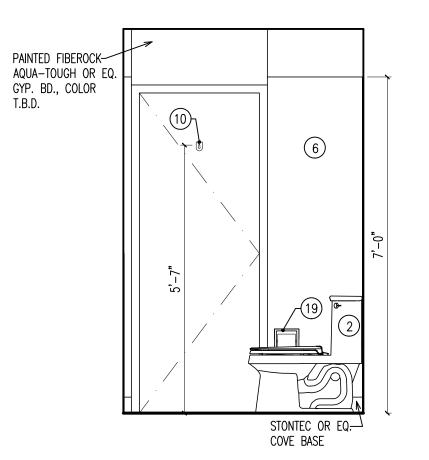



BATHROOM ELEVATIONS
S C A L E : 1/2" = 1'-0"

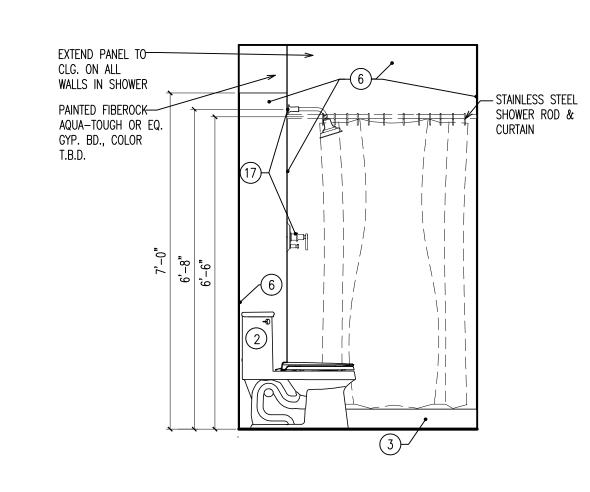





1'-7"

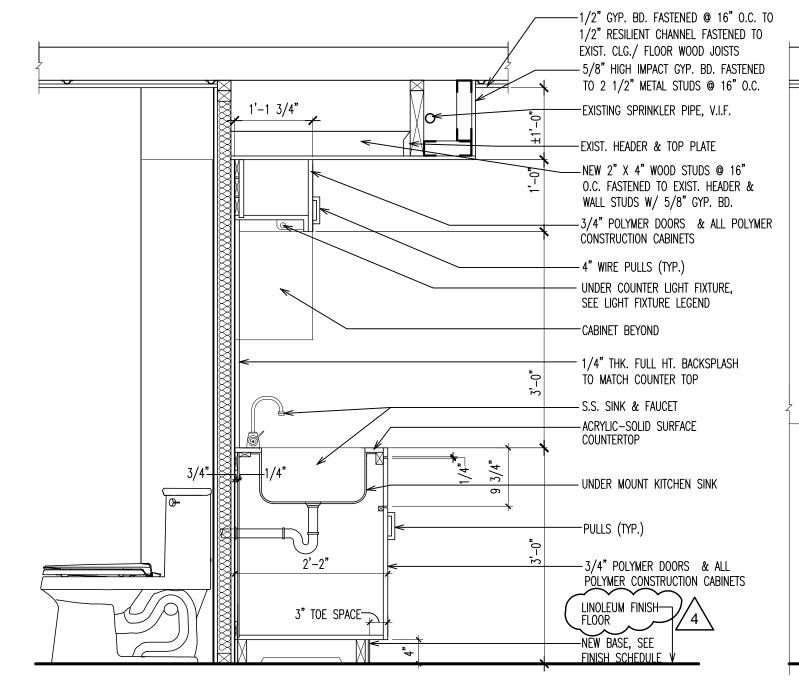

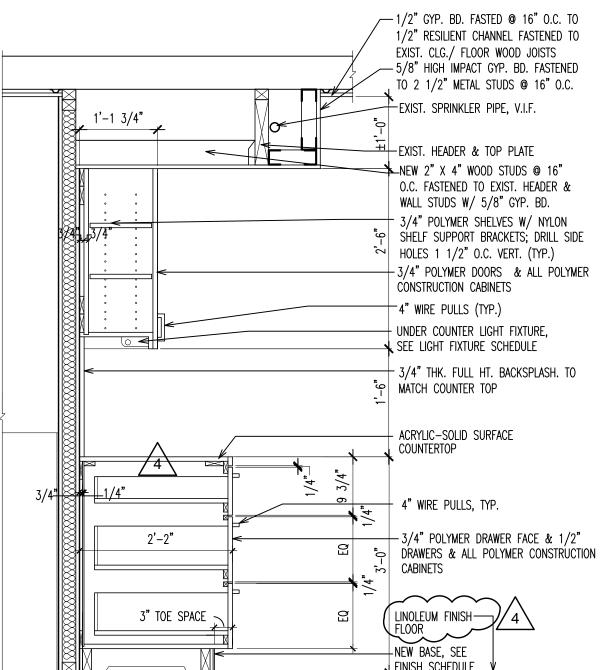


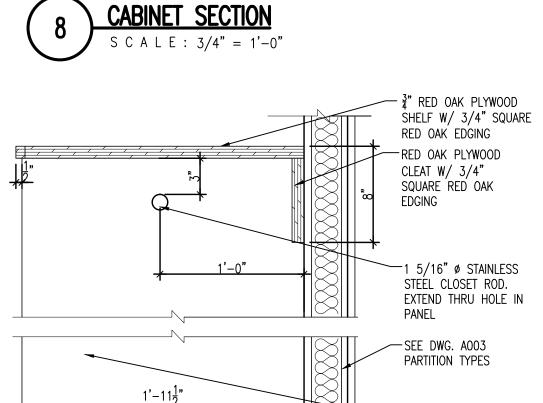


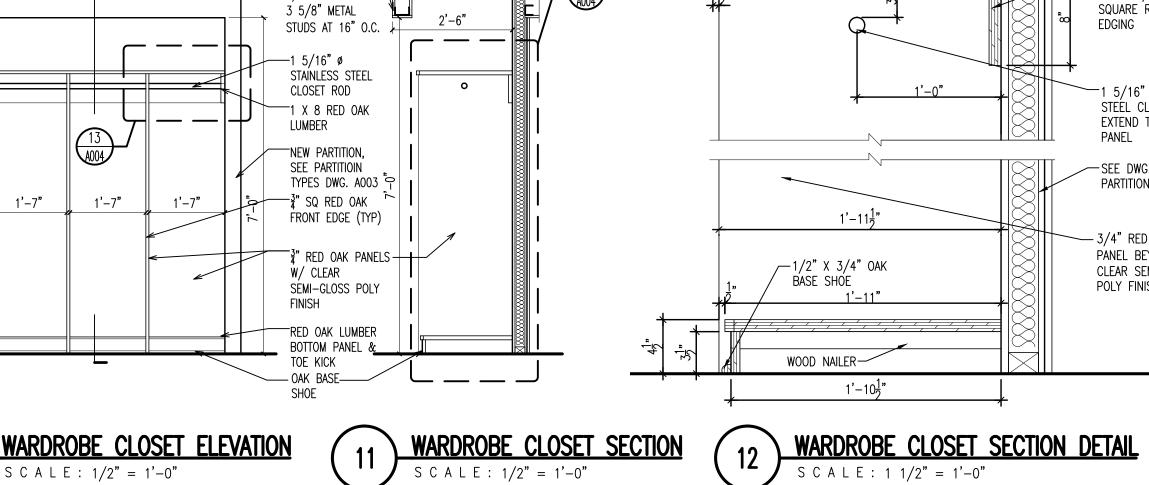

5/8" GYP. BD. ON─\

-3/4" RED OAK PANEL BEYOND W/ /—1/2" X 3/4" OAK BASE SHOE CLEAR SEMI-GLOSS POLY FINISH. WOOD NAILER $1'-10\frac{1}{2}$ "

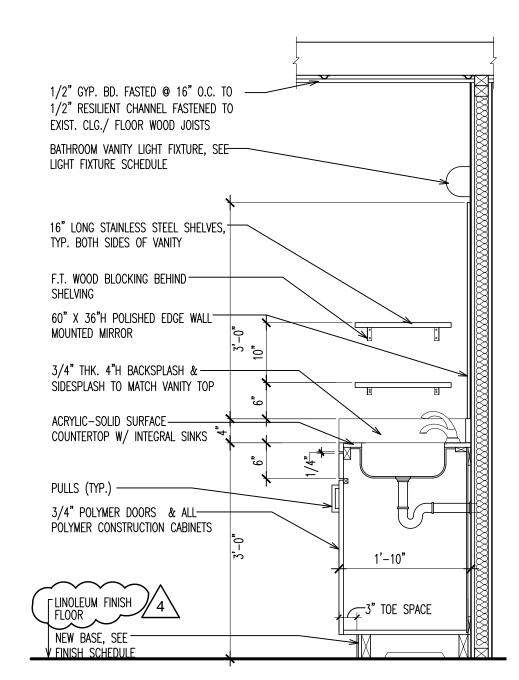

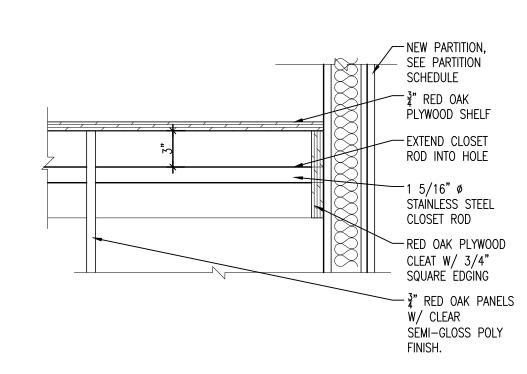


WARDROBE CLOSET ELEVATION DETAIL

S C A L E : 1 1/2" = 1'-0"

Revisions

Description ISSUED FOR DCA FILING ISSUED FOR BIDDING 03-18-15 ISSUED FOR DCA FILING & CONSTRUCTION ISSUED PER ADDENDUM 04-07-15

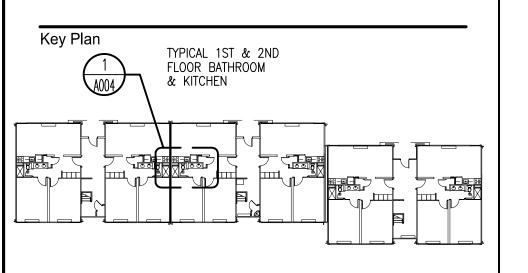

TYPICAL FLOOR

Consultants




LINWOOD ENGINEERING ASSOCIATES, P.A. **CONSULTING ENGINEERS** 955 Lincoln Avenue Glen Rock, New Jersey 07452 TELEPHONE (201) 857-3998


FAX: (201) 857-3994

INTERIOR RENOVATIONS AT THE MIMOSA - G RESIDENCE

OF NEW JERSEY 505 Ramapo Valley Road Mahwah, New Jersey 07430-1680


DCA PROJECT# 9071-15

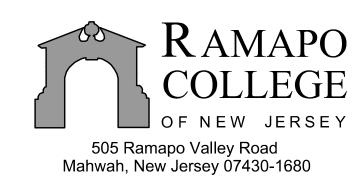

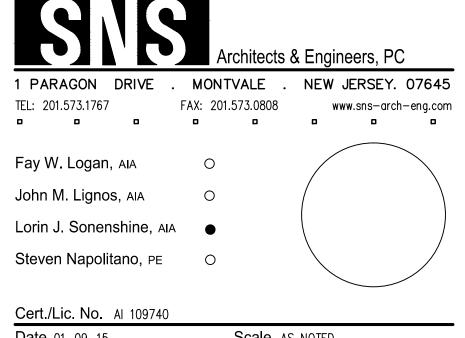

Date 01-09-15 Scale AS NOTED Drawn By DP Checked By DP

ENLARGED PLAN, MILLWORK, DETAILS & EQUIP. SCHEDULE Work Order No.

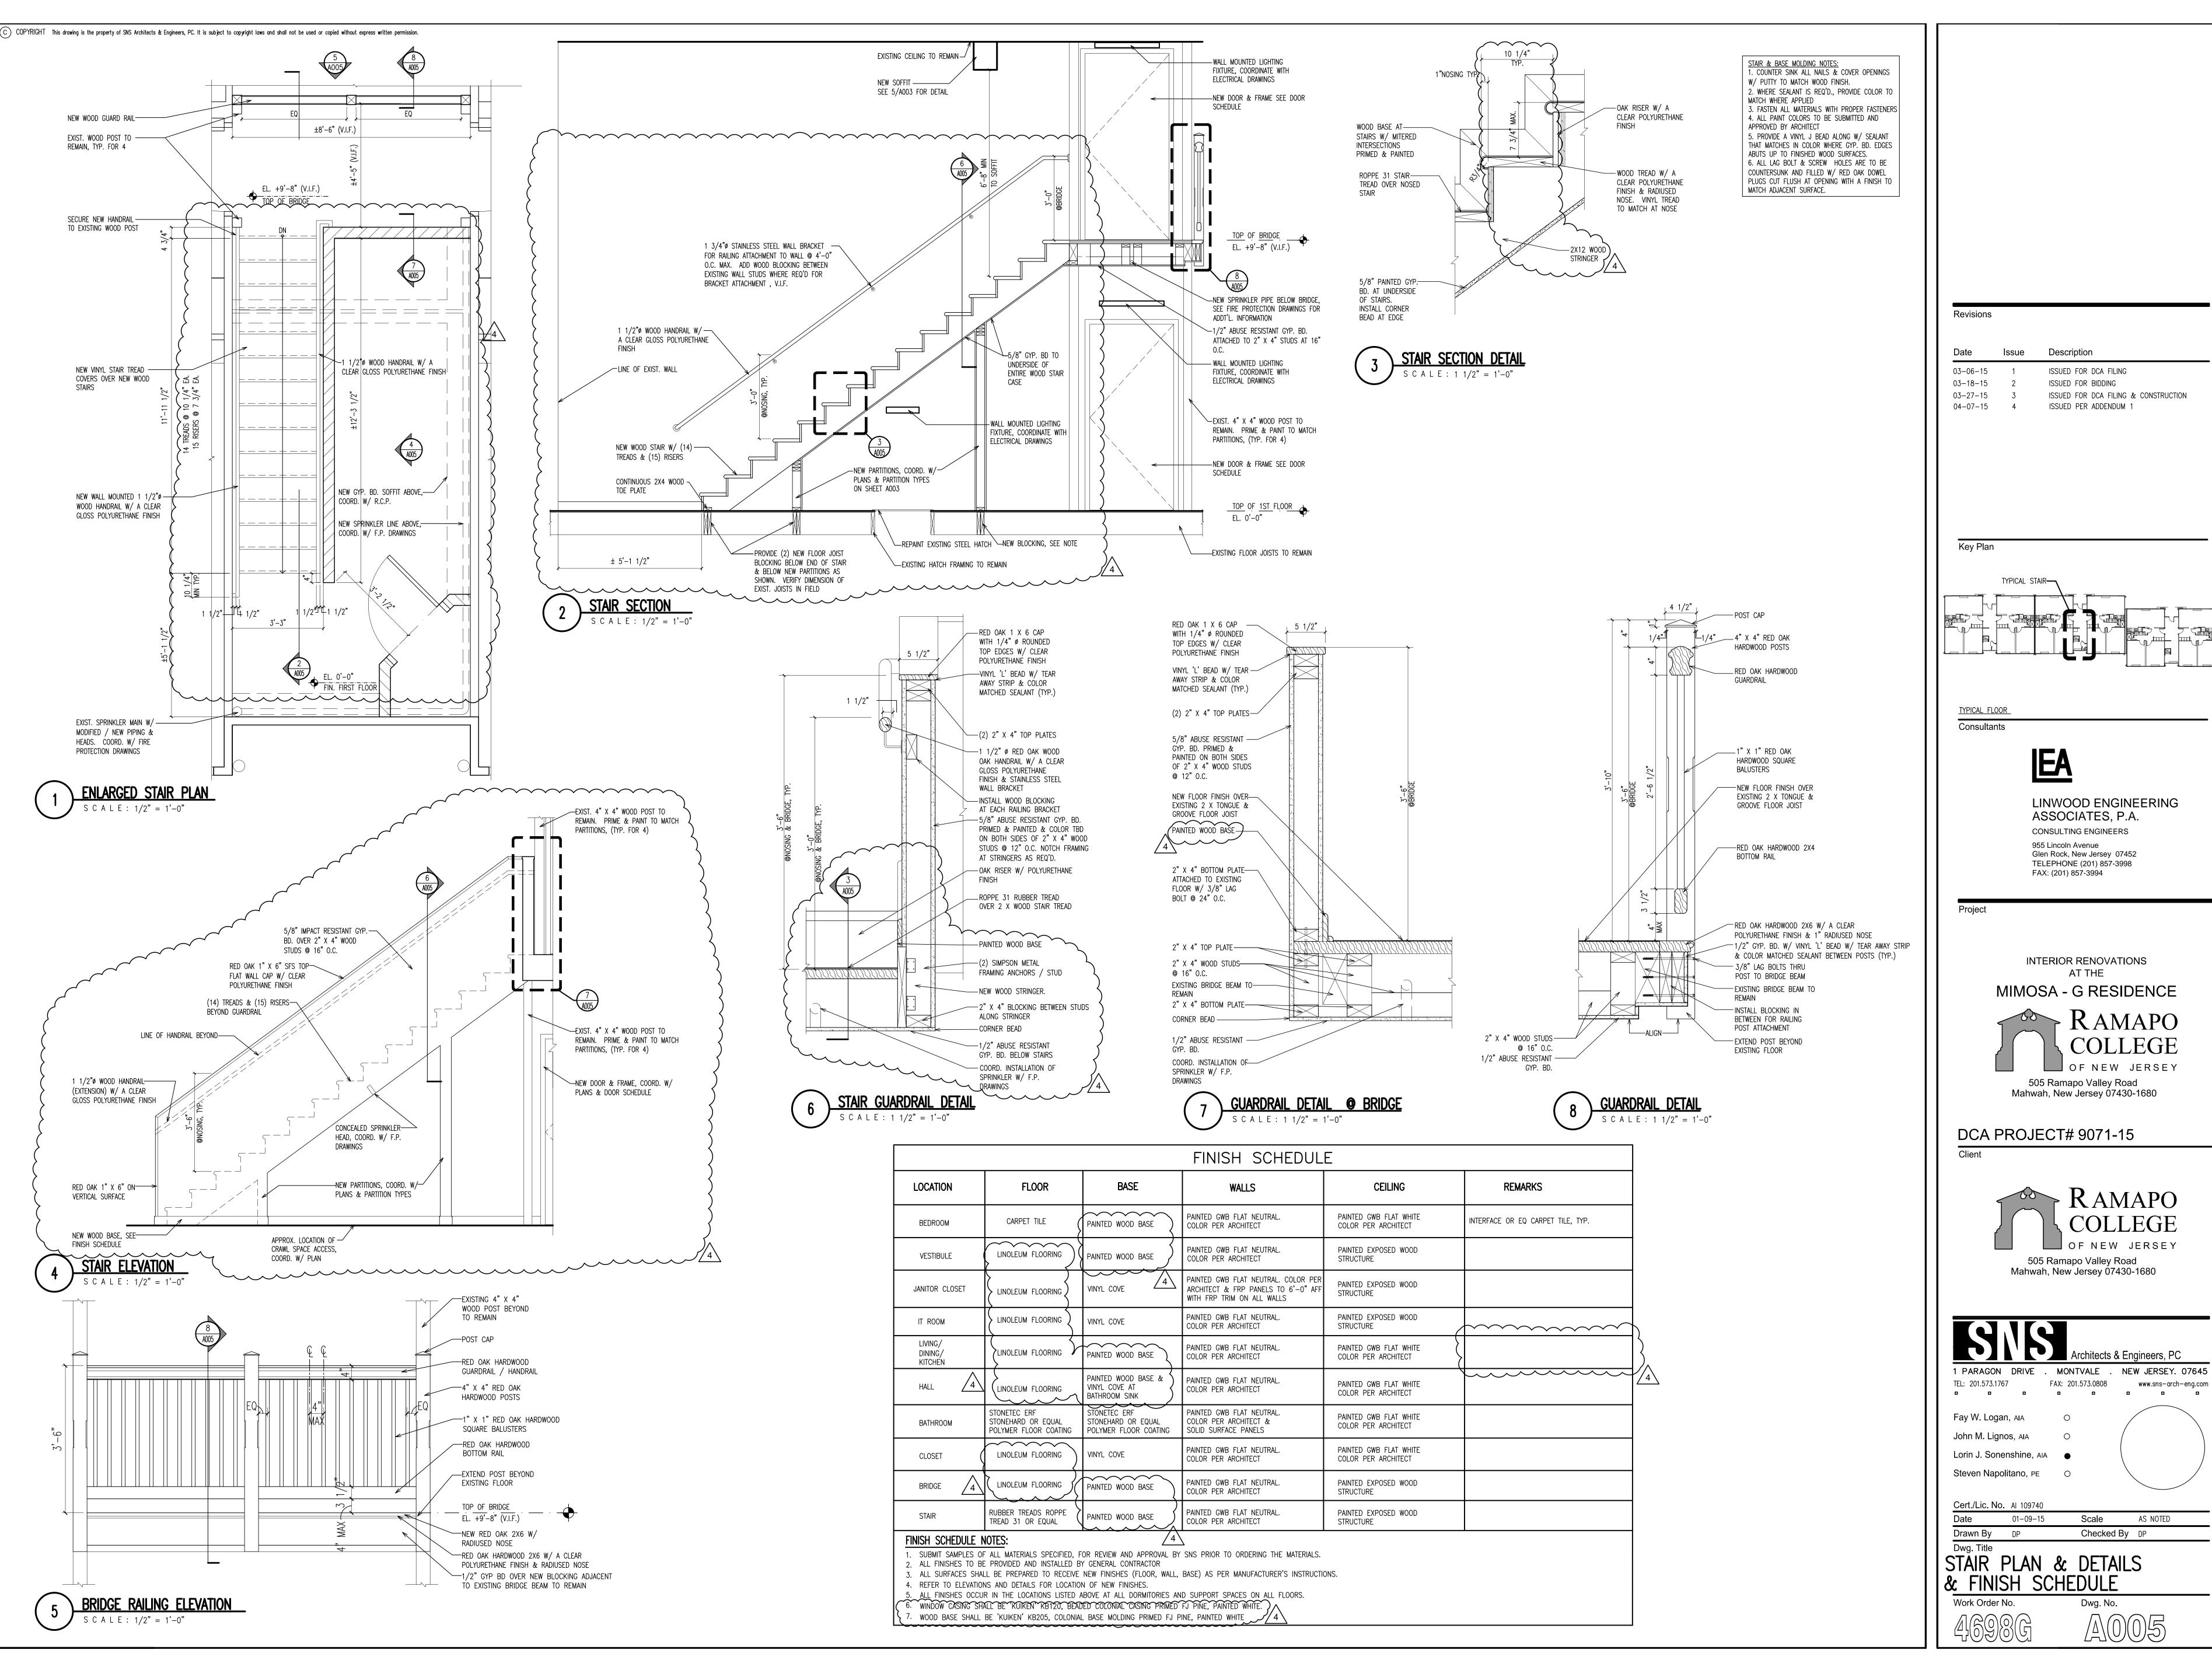

Revisions Description Issue ISSUED FOR DCA FILING ISSUED FOR BIDDING 03-18-15 03-27-15 ISSUED FOR DCA FILING & CONSTRUCTION ISSUED PER ADDENDUM 04-07-15 4 Key Plan TYPICAL STAIR-TYPICAL FLOOR Consultants LINWOOD ENGINEERING ASSOCIATES, P.A. **CONSULTING ENGINEERS** 955 Lincoln Avenue Glen Rock, New Jersey 07452 TELEPHONE (201) 857-3998 FAX: (201) 857-3994 INTERIOR RENOVATIONS AT THE MIMOSA - G RESIDENCE RAMAPO **COLLEGE** OF NEW JERSEY 505 Ramapo Valley Road Mahwah, New Jersey 07430-1680

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